ABBREVIATIONS:

HOUR **ANGLE** INSIDE DIAMETER **INSULATION** INT **ANCHOR BOLT ABOVE JANITOR ACOUSTICAL KITCHEN** LAMINATE **ADJUSTABLE** LAVATORY **ABOVE FINISH FLOOR** LBS **POUNDS AGGREGATE** LTG **MEDIUM DENSITY ALTERNATE MATERIAL APPROXIMATE MAXIMUM ARCH MECHANICAL MANUFACTURER BATHROOM** MH **MANHOLE** MINIMUM **MISCELLANEOUS BOARD** MOUNTED MUL MULLION **BLOCKING** NORTH **BEDROOM NOT IN CONTRACT** BTM NOT TO SCALE **CATCH BASIN** NO NUMBER NOM NOMINAL **CEILING HEIGHT** ON CENTER C.I. CAST IRON O.D. **OUTSIDE DIAMETER CONTROL JOINT CONCRETE MASONRY UNIT** OFF **OFFICE OPERABLE** C.O. **CLEAN OUT** OPPOSITE **COLD WATER** PLASTIC LAMINATE PRESSURE TREATED CARP PERFORATED **PERPENDICULAR** CLG CAULKING PROPERTY LINE **PLATE** CLR PLYWOOD COL **PROPERTY** CONC CONCRETE **PAINT** CONT CONTINUOUS POLYVINYL CHLORIDE CTR QTY QUANTITY DRINKING FOUNTAIN DET RESILIENT CHANNEL **DOUBLE HUNG** R.C.P REFLECTED CEILING PLAN R.D. **ROOF DRAIN** DIMENSION R.O. **ROUGH OPENING** DISPENSER **RAIN WATER LEADER** DOWN **RADIUS** DOWNSPOUT REFERENCE REFRIGERATOR **EXHAUST FAN** REQD REQUIRED **EXPANSION JOINT REV REVISION ELEVATION ELECTRICAL** RM **ROOM ELEV ELEVATOR** RWD **REDWOOD EMER EMERGENCY** SOUTH **ENG ENGINEER** S.C. SOLID CORE **EQUAL** SEE ELECTRCIAL DWGS **EQPT EQUIPMENT** S.J SEISMIC JOINT EXT **EXTERIOR** S.S. STAINLESS STEEL FIRE ALARM SEE STRUCTURAL DWGS S.S.D F.C.O. FLOOR CLEAN OUT **SCHED** SCHEDULE F.D. FLOOR DRAIN SECT SECTION FIRE EXTINGUISHER F.E. SHGT SHEATHING FIRE EXTINGUISHER CABINET F.E.C. SHT SHEET **FURNITURE, FIXTURES AND** F.F&E **EQUIPMENT** SIMILAR FINISH FLOOR SKY LIGHT F.O. **FACE OF SPECIFICATION** FIRE SPRINKLER SQ **SQUARE** F.S. STD STANDARD STL FIXT **FIXTURE** STEEL STORAGE FLR **FLOOR** STOR STRUC STRUCTURAL FND **FOUNDATION** SUSP SUSPENDED **FPRF FIREPROOF TREAD** T.O. FT **FOOT OR FEET** TOP OF T.O.P. **TOP OF PLATE** FTG **FOOTING** T.O.S. **TOP OF SLAB** G.B. **GRAB BAR** GAUGE T.O.W. **TOP OF WALL** TEL GALV **GALVANIZED TELEPHONE TEMP** GROUND FAULT INTERRUPTER **TEMPERED**

THICK

TYPICAL

URINAL

VARIES

WEST

UNFINISHED

WATER CLOSET

WATER GLASS

WALL MOUNT

WHERE OCCURS

WATER RESISTANT

WOVEN WIRE MESH

WASHER / DRYER

WATERPROOFING

WITHOUT

WINDOW

WEIGHT

WOOD

WIRE WELDED FABRIC

UNLESS OTHERWISE NOTED

VINYL COMPOSITION TILE

TYP

UNF

UR

V.C.T

VAR

W

W.G.

W.M.

W.O.

W.R.

W/D

W/O

WD

WP

WT

WDW

W.W.F

W.W.M

U.O.N.

GLASS

GND

H.W.

HGT

GYP. BD.

GROUND

HOSE BIB

HAND RAIL

HEADER

HEIGHT

HOT WATER

GYPSUM BOARD

HOLLOW CORE

HOLLOW METAL


SYMBOLS:



DETAIL: Detail Number Sheet Number



SECTION: **Detail Number** Sheet Number

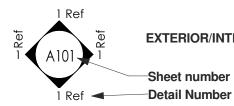

EXTERIOR/INTERIOR ELEVATION




ELEVATION HEIGHT



DOOR TAG



WINDOW TAG

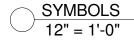

AERIAL MAP



VICINITY MAP



180 WINDING WAY



PROJECT TEAM:

NATE TEISMANN, VENITA CHANDRA 4505 DAVEY GLEN ROAD BELMONT, CA 94002

ARCHITECT: 120 MANOR DRIVE SAN FRANCISCO, CA 94127 TEL: 415 359 7504 **EMAIL: JAMES@EDITARCH.COM**

CIVIL ENGINEER: KOC ENGINEERING KEVIN O'CONNER 3401 LAWTON ST SAN FRANCISCO, CA 94122 TEL: 415 286 3422 **EMAIL: KEVINO@KOCENGINEERING.COM**

APPLICABLE CODES:

2016 California Building Code 2016 California Energy Code 2016 California Plumbing Code 2016 California Mechanical Code 2016 California Electrical Code

6300.3.50 BUILDING SITE

COVERAGE AREA RATIO

6300.3.90 BUILDING HEIGHT

6300.3.60 BUILDING FLOOR AREA

With San Mateo County Amendments

PROJECT INFORMATION

SINGLE FAMILY RESIDENCE + SECONDARY **DWELLING UNIT DESCRIPTION:**

3 STORY, PLUS BASEMENT, HOME WITH SECONDARY DWELLING UNIT AND ATTACHED GARAGE. INCLUDES 6 BEDRROM ROOMS, 6 **BATHROOMS AND 2 WATER CLOSETS.** 049-141-580

LOCAL JURISDICTION: SAN MATEO COUNTY SUBDIVISION: DEVONSHIRE R-3 SINGLE FAMILY CONSTRUCTION

OCCUPANCY CLASS: R-1 / S-71 / DR **BASE ZONING: CLIMATE ZONE:**

YES, CLASS A **WUI ZONE:**

MATERIALS NOTES:

BUILDING IS LOCATED IN AN LRA HIGH FIRE HASARD SEVERITY ZONE. ALL **EXTERIOR MATERIALS AND** CONSTRUCTION METHODS SHALL MEET **EXTERIOR WILDFIRE EXPOSURE** STANDARDS, CBC 7A

SAN MATEO COUNTY ZONING REGULATIONS ANALYSIS

SECTION REQUIRED **PROPOSED** 6300.3.10 BUILDING SITE WIDTH 50 FEET 6300.3.20 BUILDING SITE AREA 5,000 SQ. FT. MIN. 28,924 SQ. FT. 1 UNIT/ACRE + 6300.3.30 DEVELOPMENT DENSITY 8.7 UNITS/ACRE SECONDARY DWELLING UNIT 6300.3.40 BUILDING SETBACKS FRONT 20 FEET 20 FEET NORTH 35'-4", SOUTH 16'-5", EAST 54'-1" SIDE 5 FEET

30 FEET MAX

20 FEET 50% (14,462 SQ. FT.) 4,833 SQ FT, 16.7% 4,100 SQ FT MAX 4,098 SQ FT


28 FEET



TEISMANN CHANDRA

180 WINDING WAY SAN CARLOS, CA 94070

BLOCK/LOT:Project Number

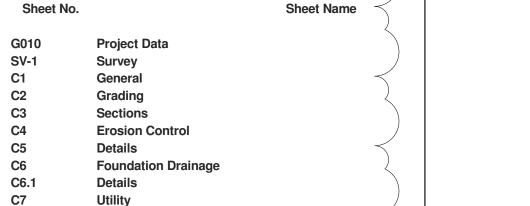

SHEET LIST

Landscape Plan

Site Plan

1st Floor Plan

2nd Floor Plan

3rd Floor Plan

Elevations North

Elevations West

Elevations East

Lateral Sections

BUILDING AREA CALCULATIONS

(706) SQ FT

447 SQ FT

1200 SQ FT

2065 SQ FT

786 SQ FT

4498 SQ FT

4,098 SQ FT

585 SQ FT

730 SQ FT

955 SQ FT

1141 SQ FT

361 SQ FT

1061 SQ FT

4,833 SQ FT

Elevations South

Longitudinal Section

Roof Plan

Tree Protection Plan

Basement Floor Plan

Building Area Calculations

C8

A100

A101

A102

A103

A104

A105

A106

A200

A201

A202

A203

A300

A301

BASEMENT

1ST FLOOR

...GARAGE

2ND FLOOR

3RD FLOOR

PARKING PAD

1ST FLOOR DECK

...SECONDARY DWELLING UNIT

TOTAL BUILDING FLOOR AREA

BUILDING SITE COVERAGE

2ND FLOOR ROOF DECK

3RD FLOOR ROOF DECK

2ND FLOOR AT ENTRY PATIO


3RD FLOOR BUILDING AND ROOF


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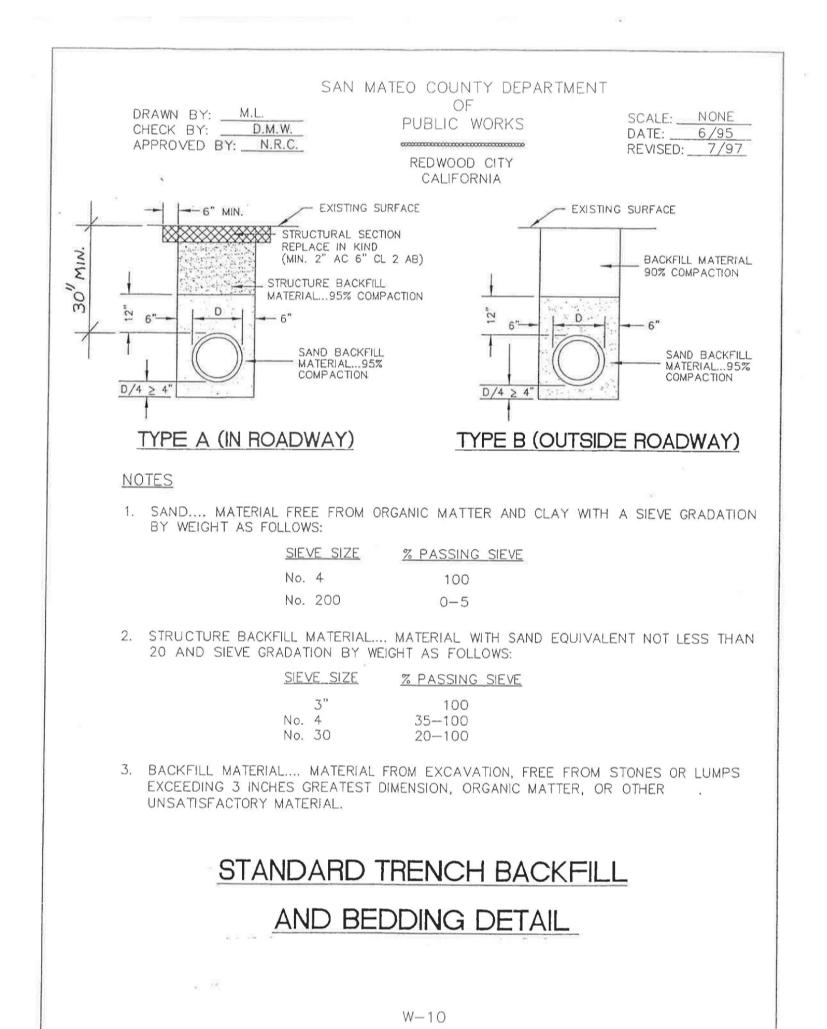









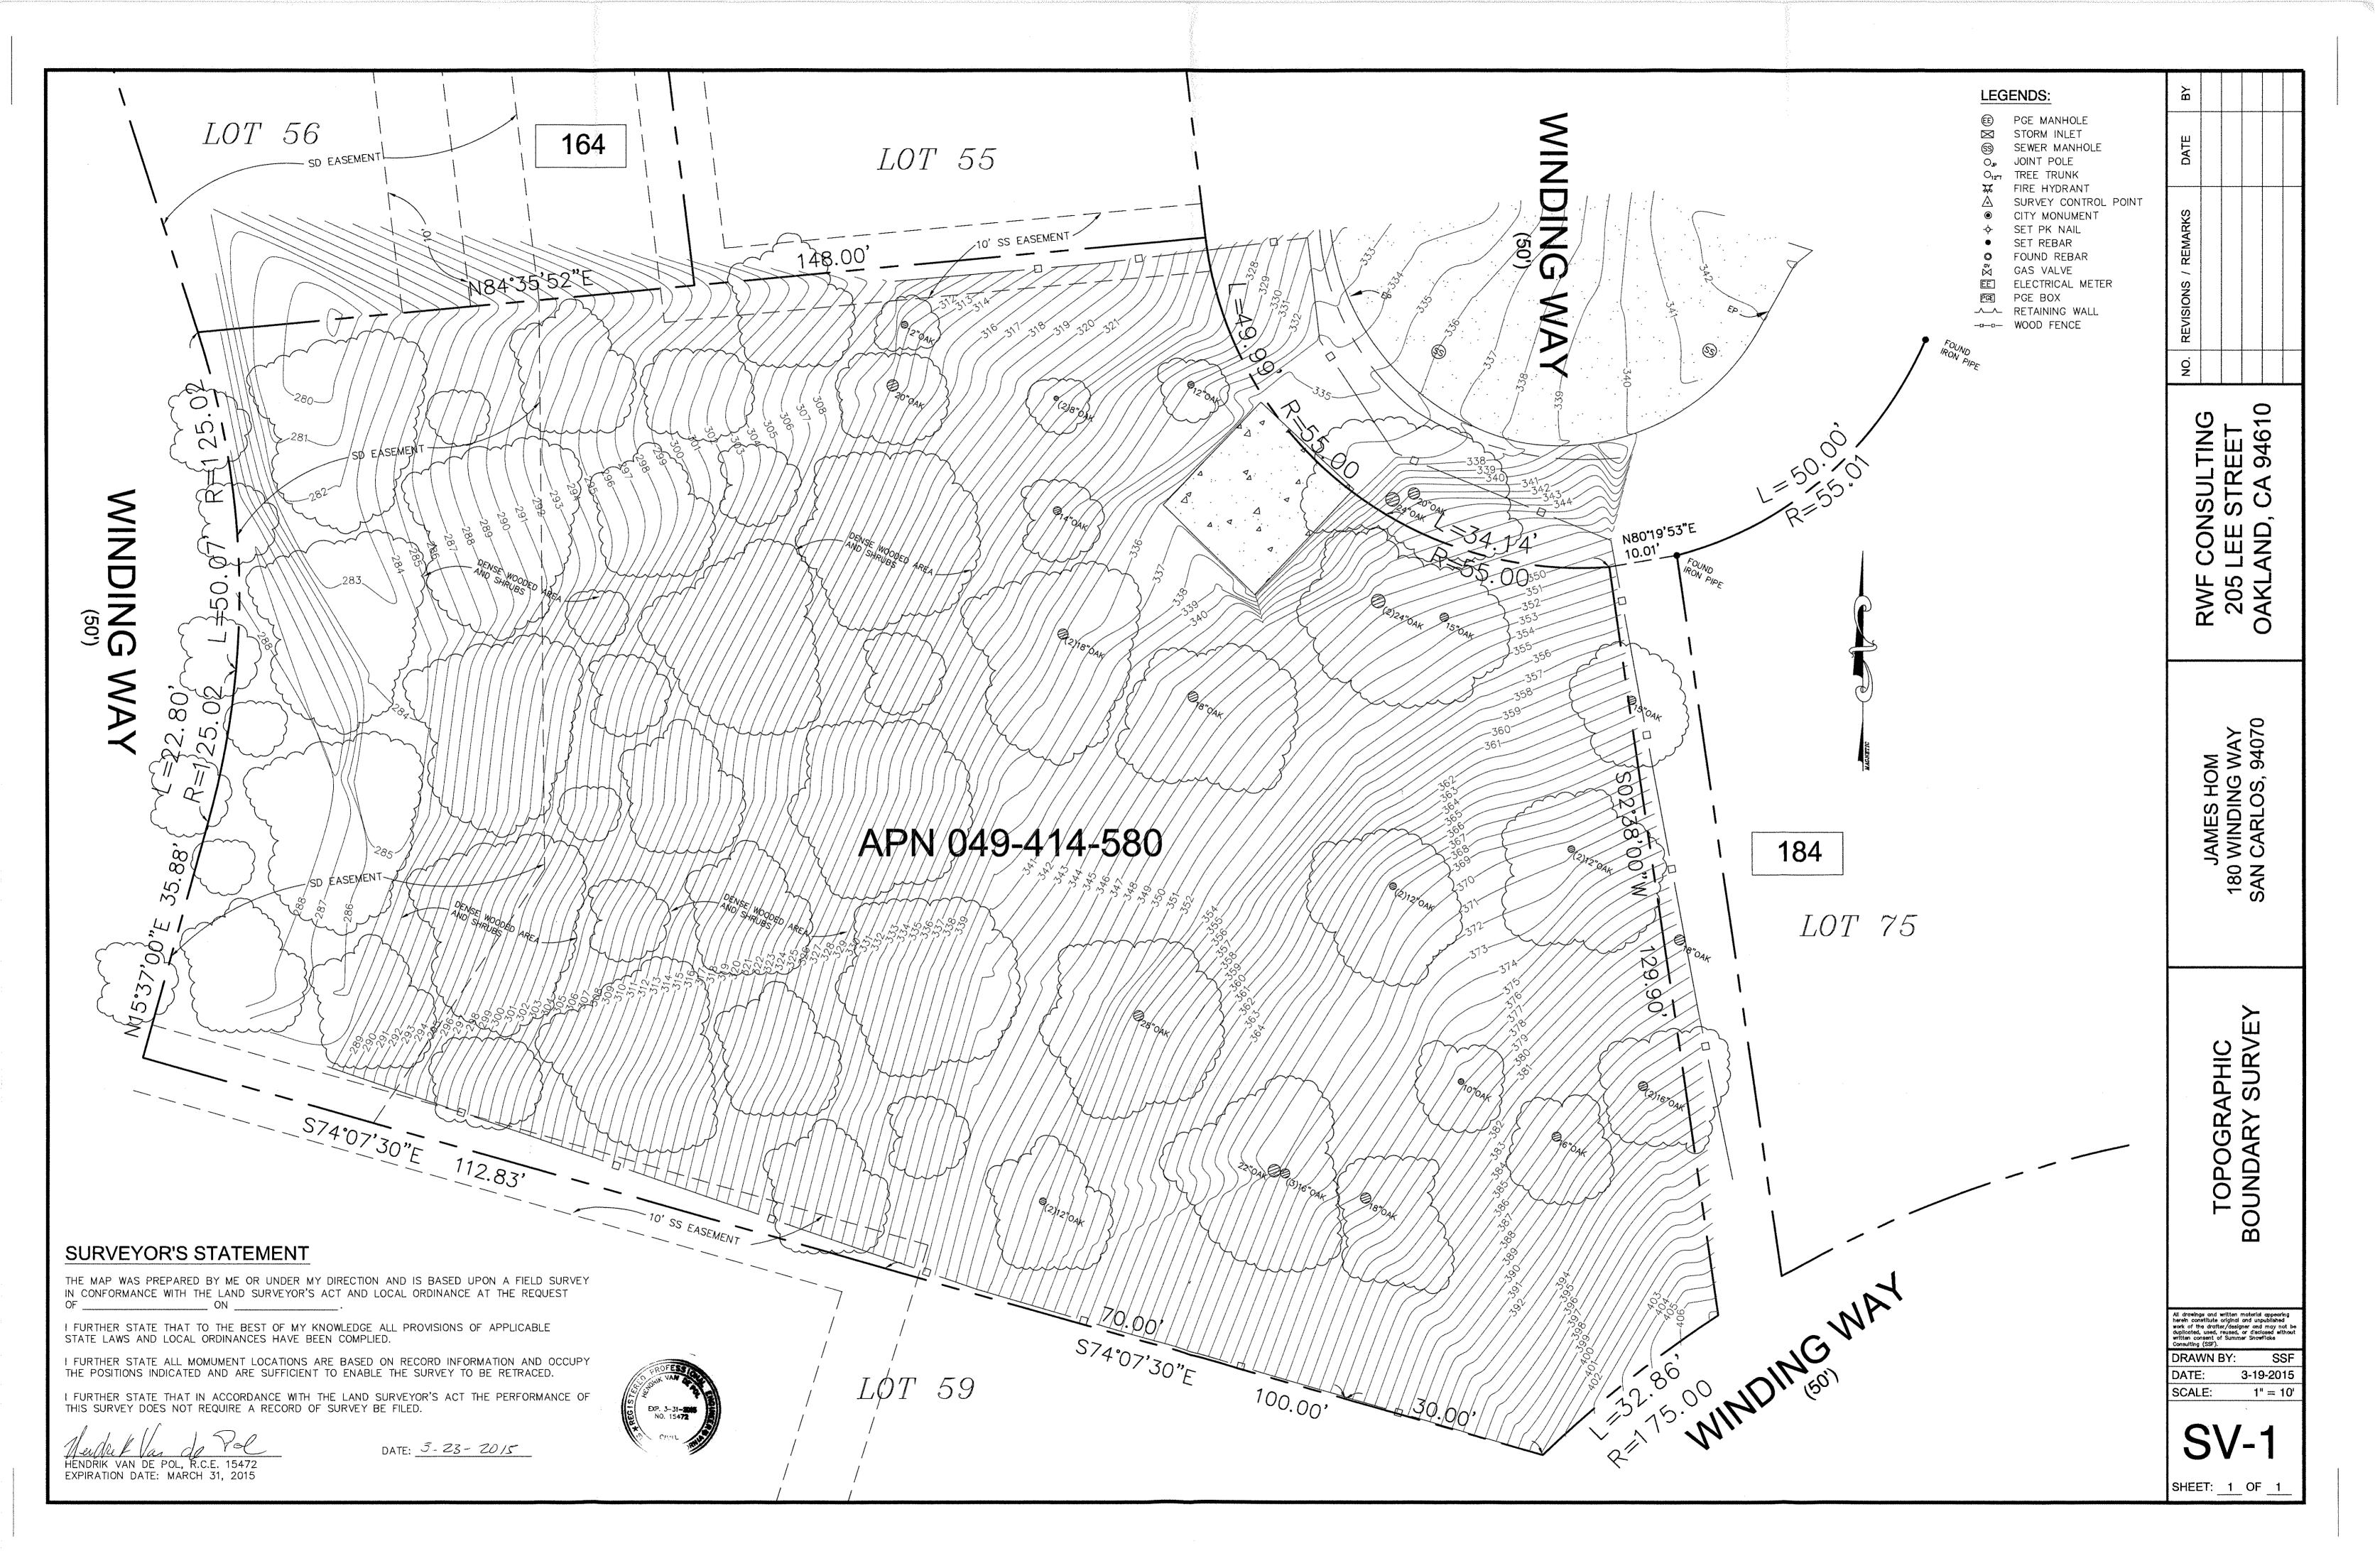

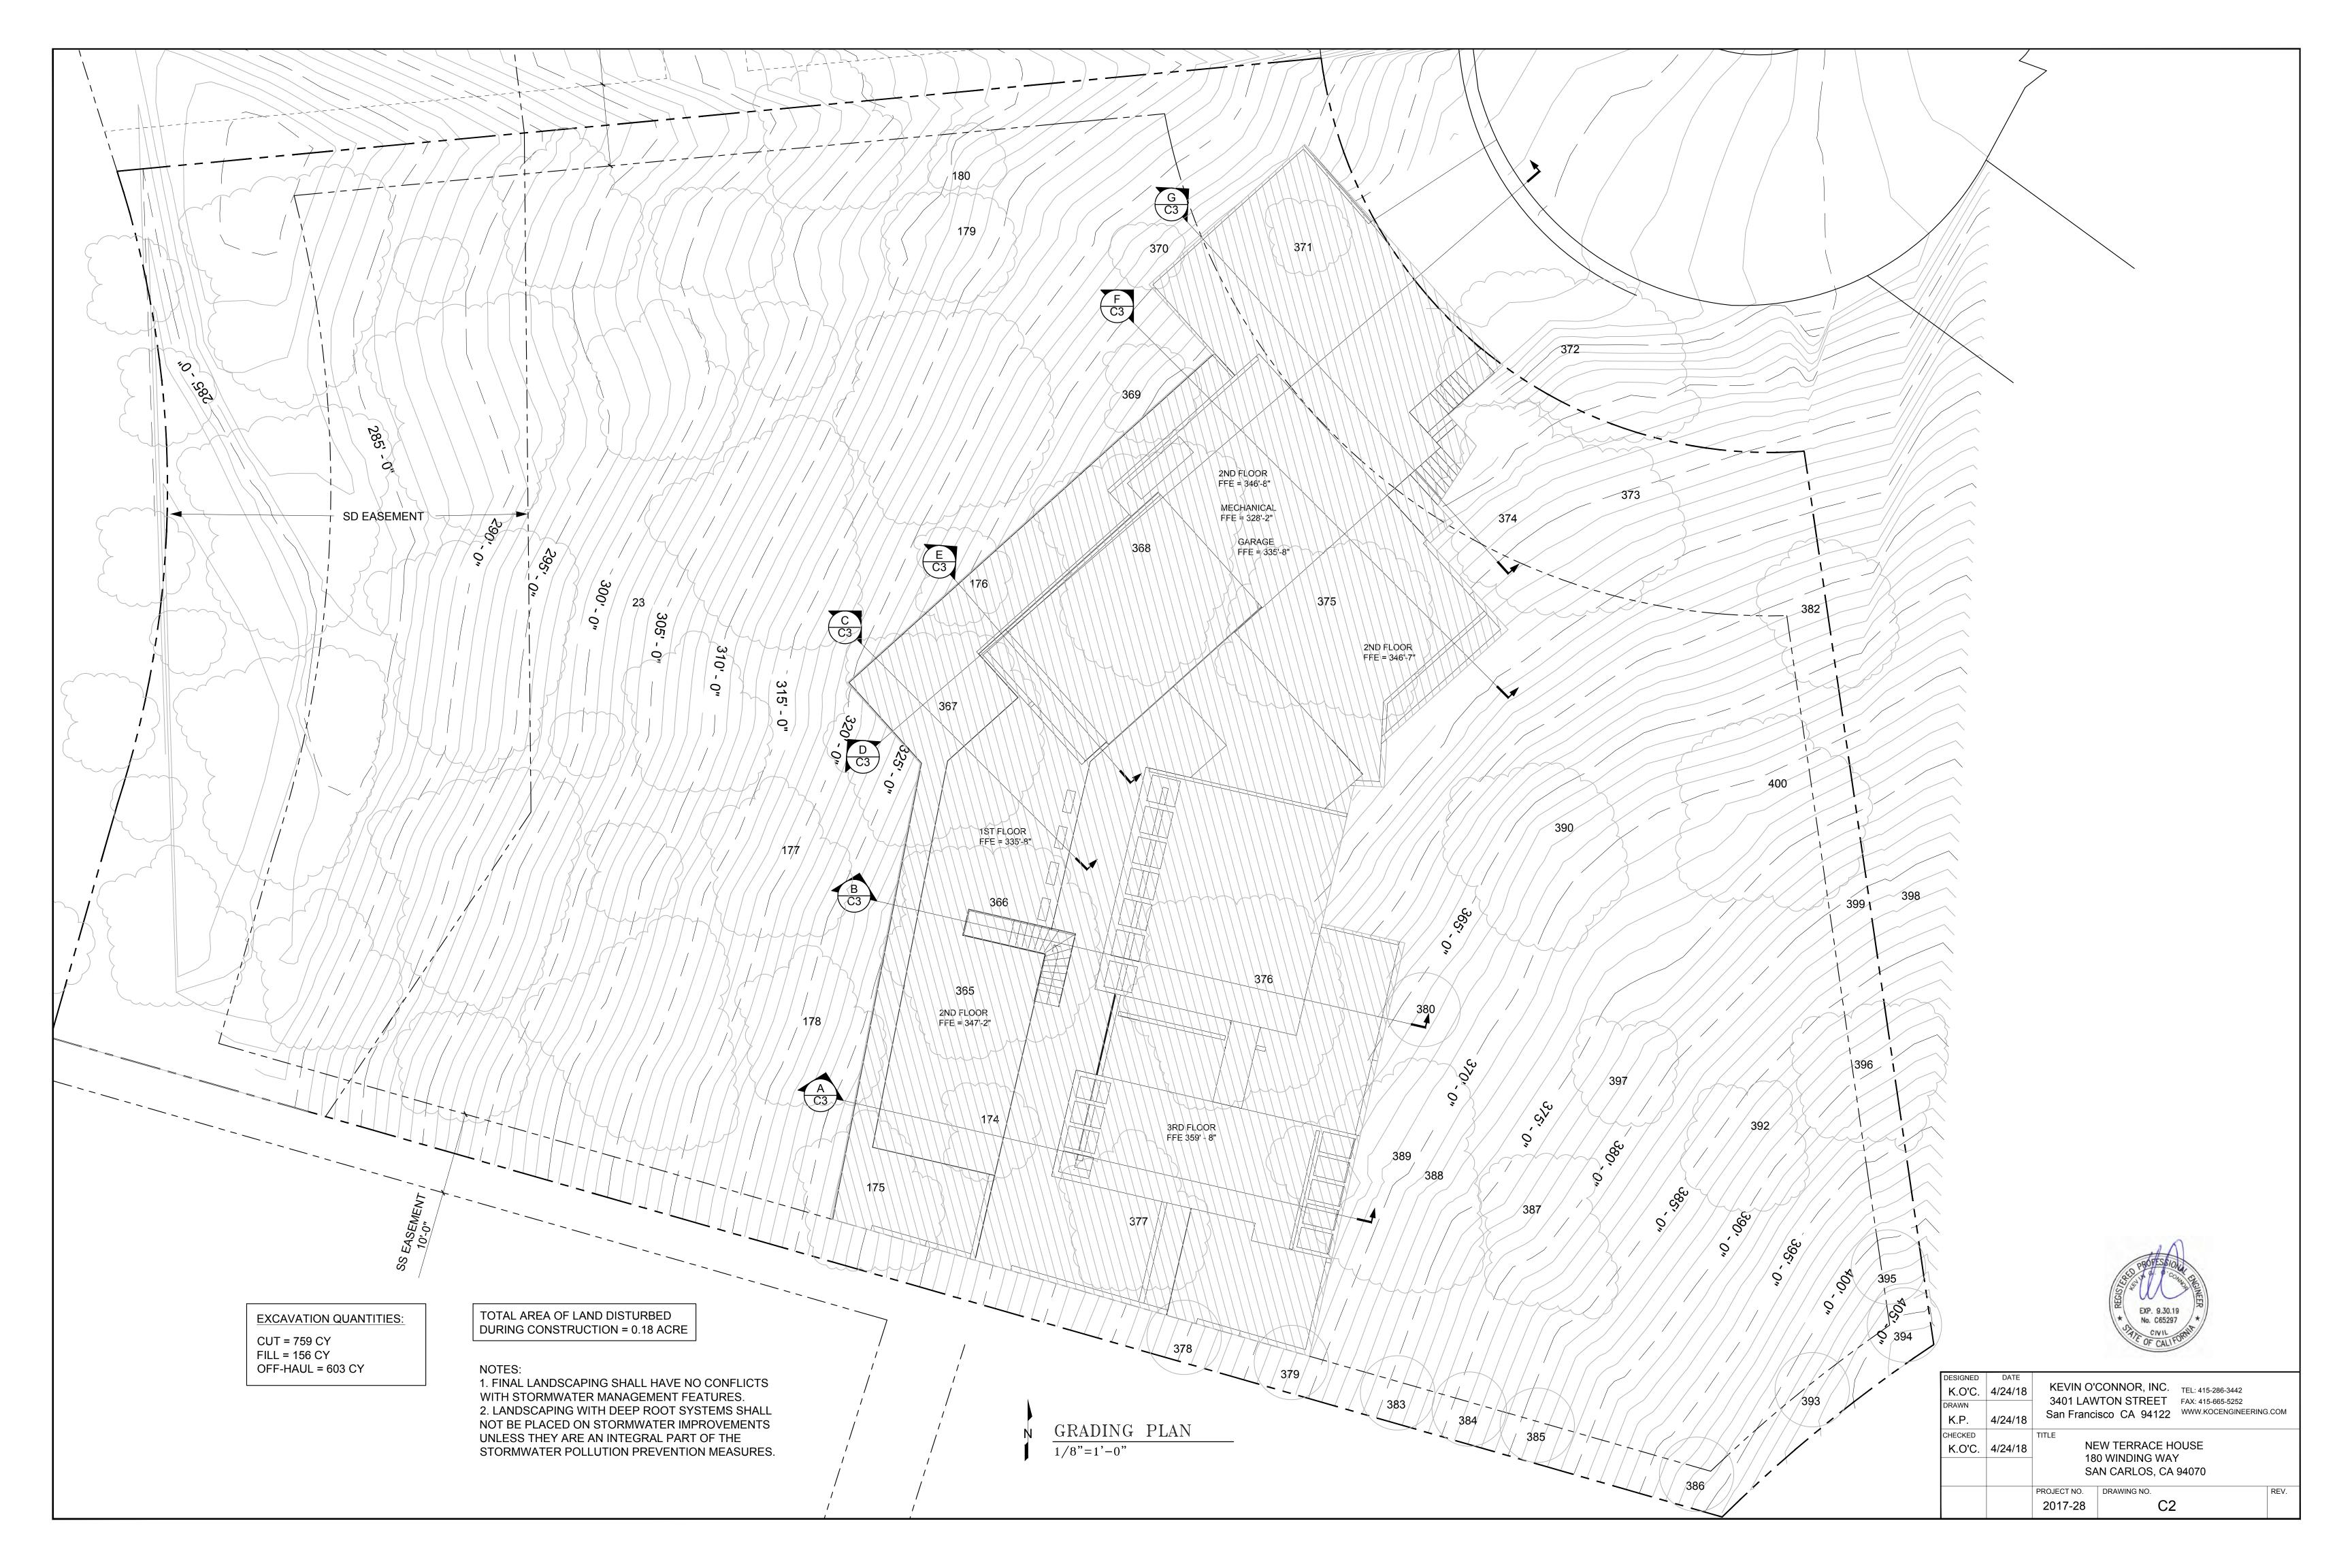


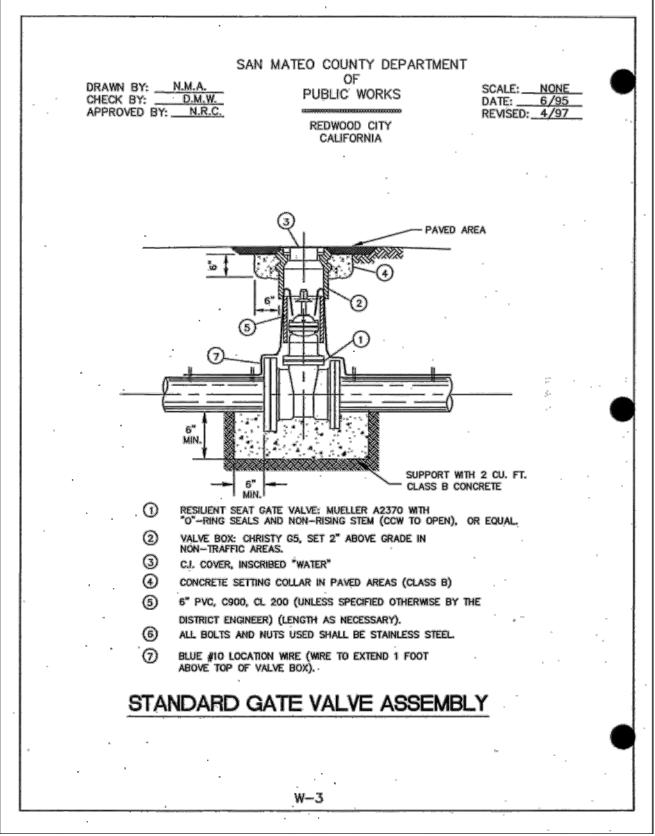


NTS



			CAL		
DESIGNED K.O'C.	DATE 4/24/18		CONNOR, INC. /TON STREET	TEL: 415-286-3442 FAX: 415-665-5252	
K.P.	4/24/18		sco CA 94122	WWW.KOCENGINEERING	G.COM
CHECKED K.O'C.	4/24/18	NEW TERRACE HOUSE 180 WINDING WAY			
			AN CARLOS, CA	-	
		PROJECT NO. 2017-28	DRAWING NO.	,	REV.

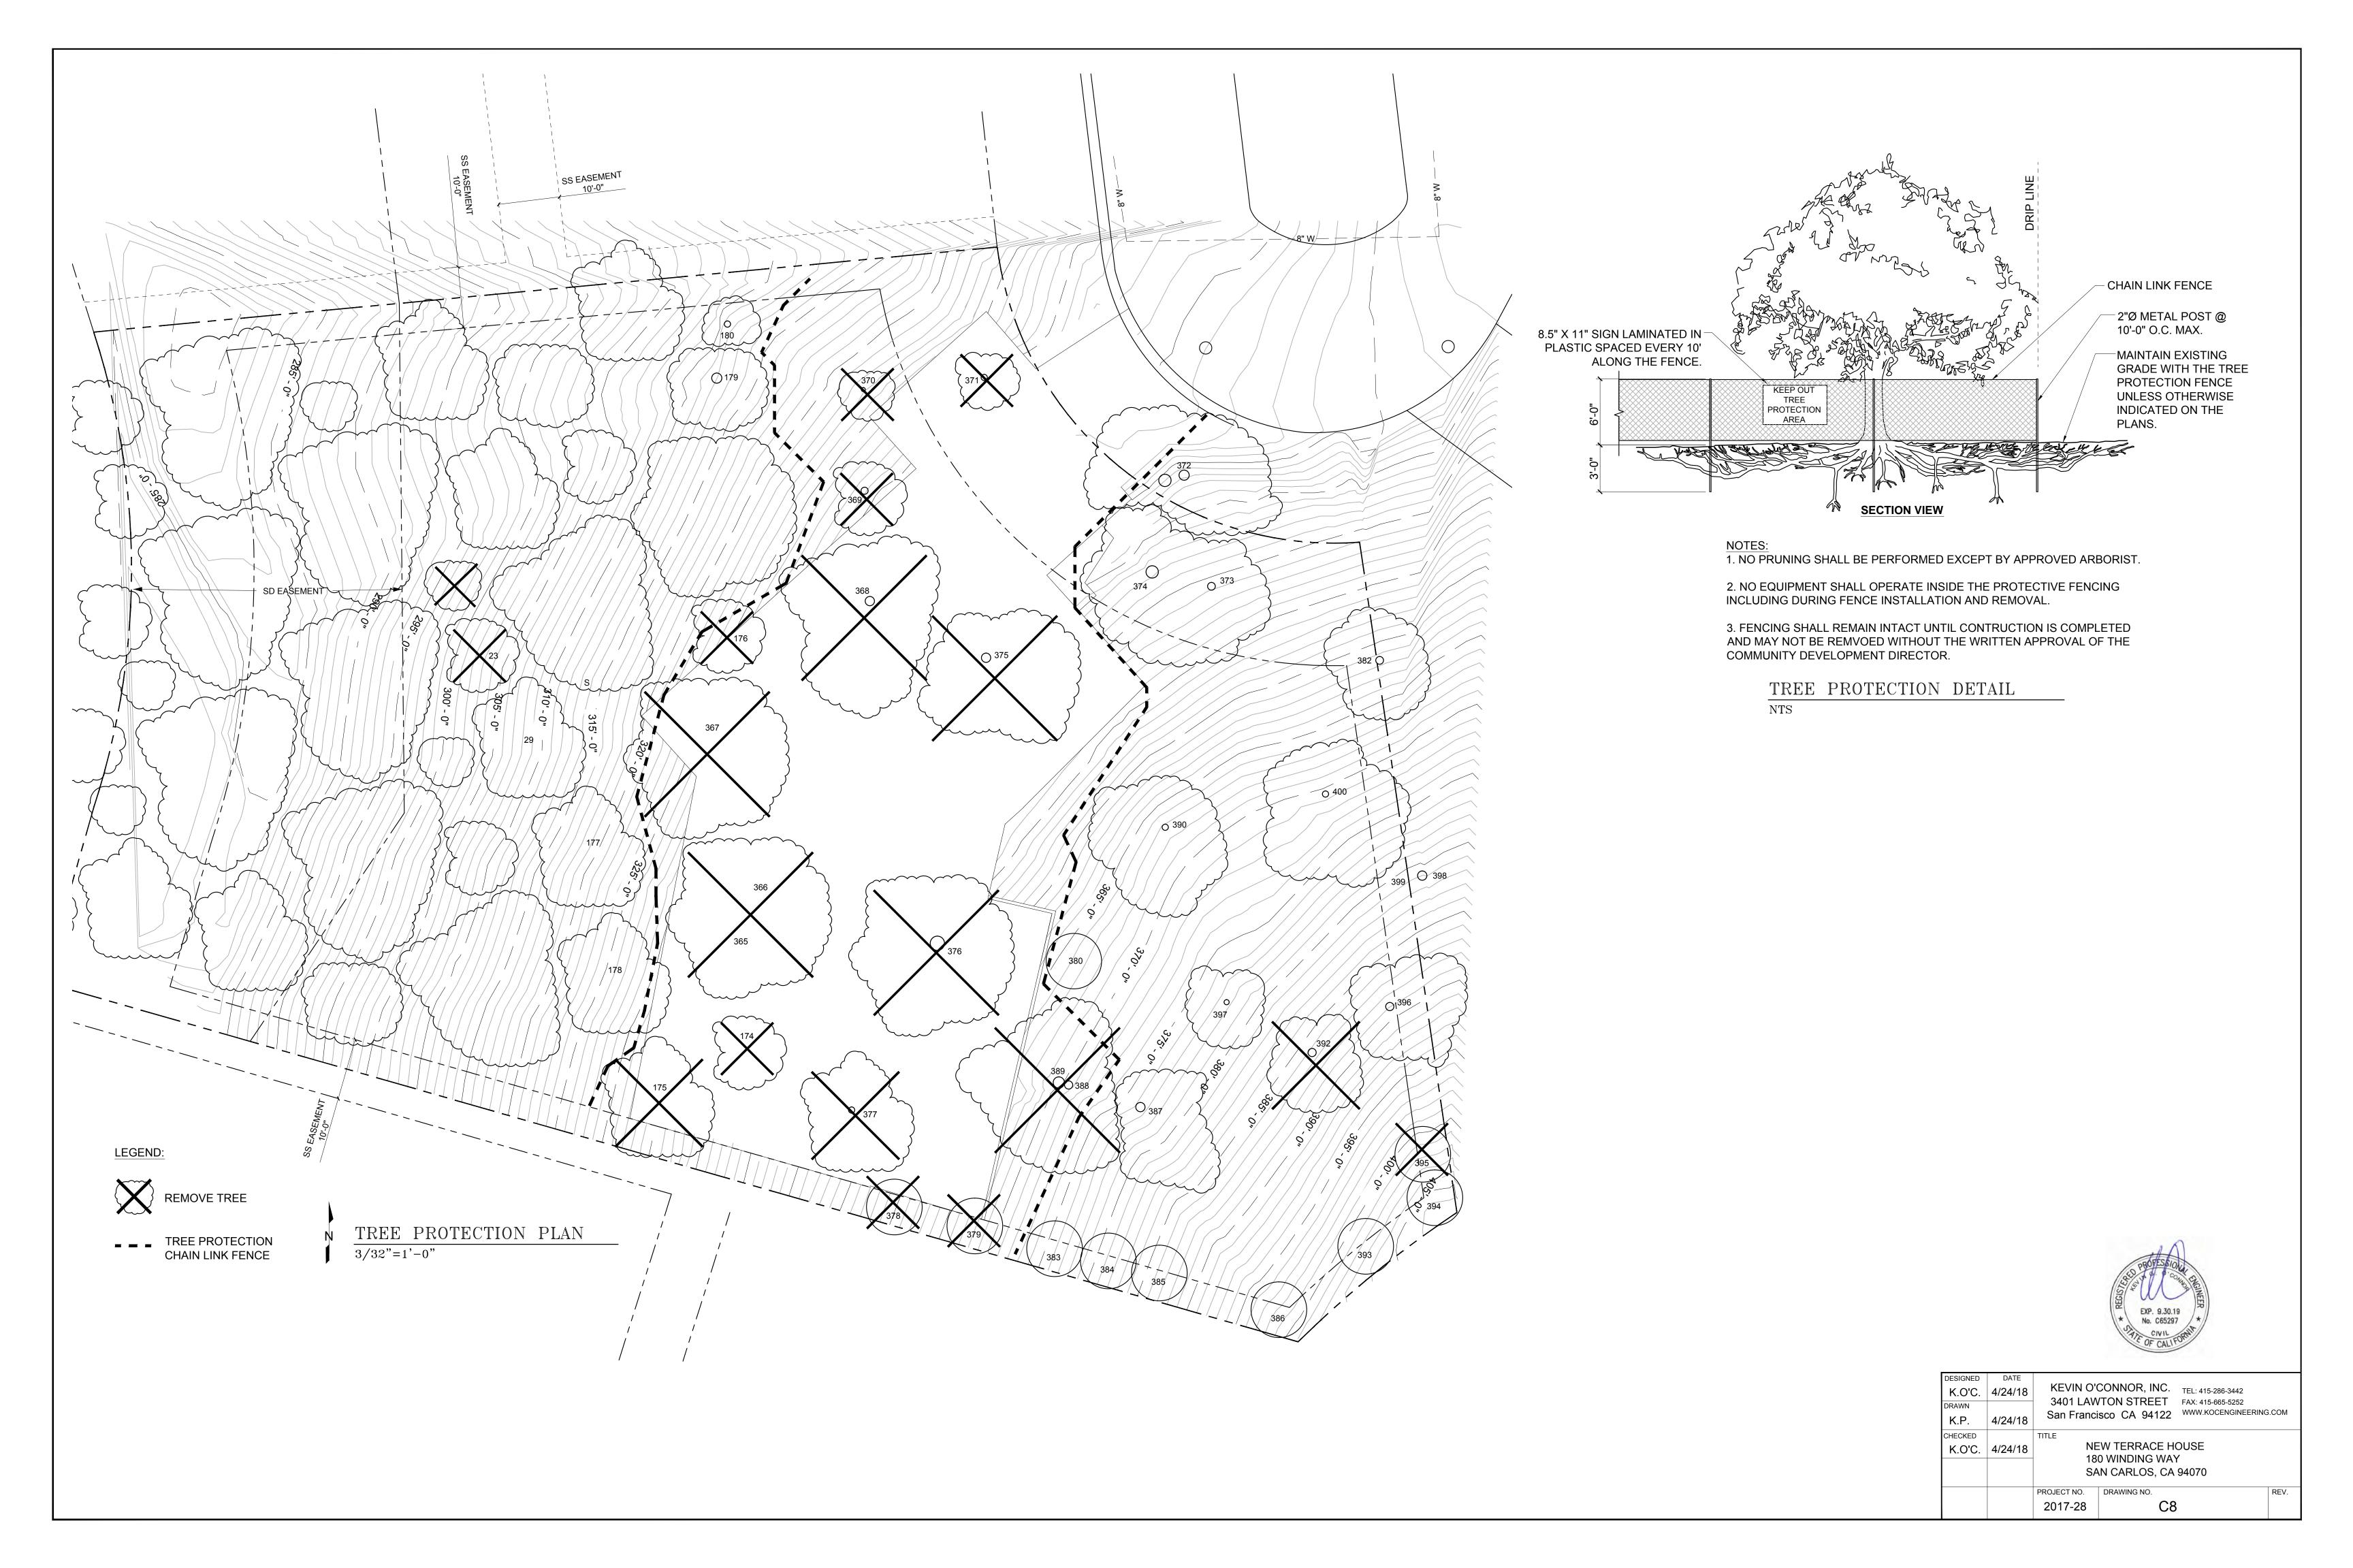

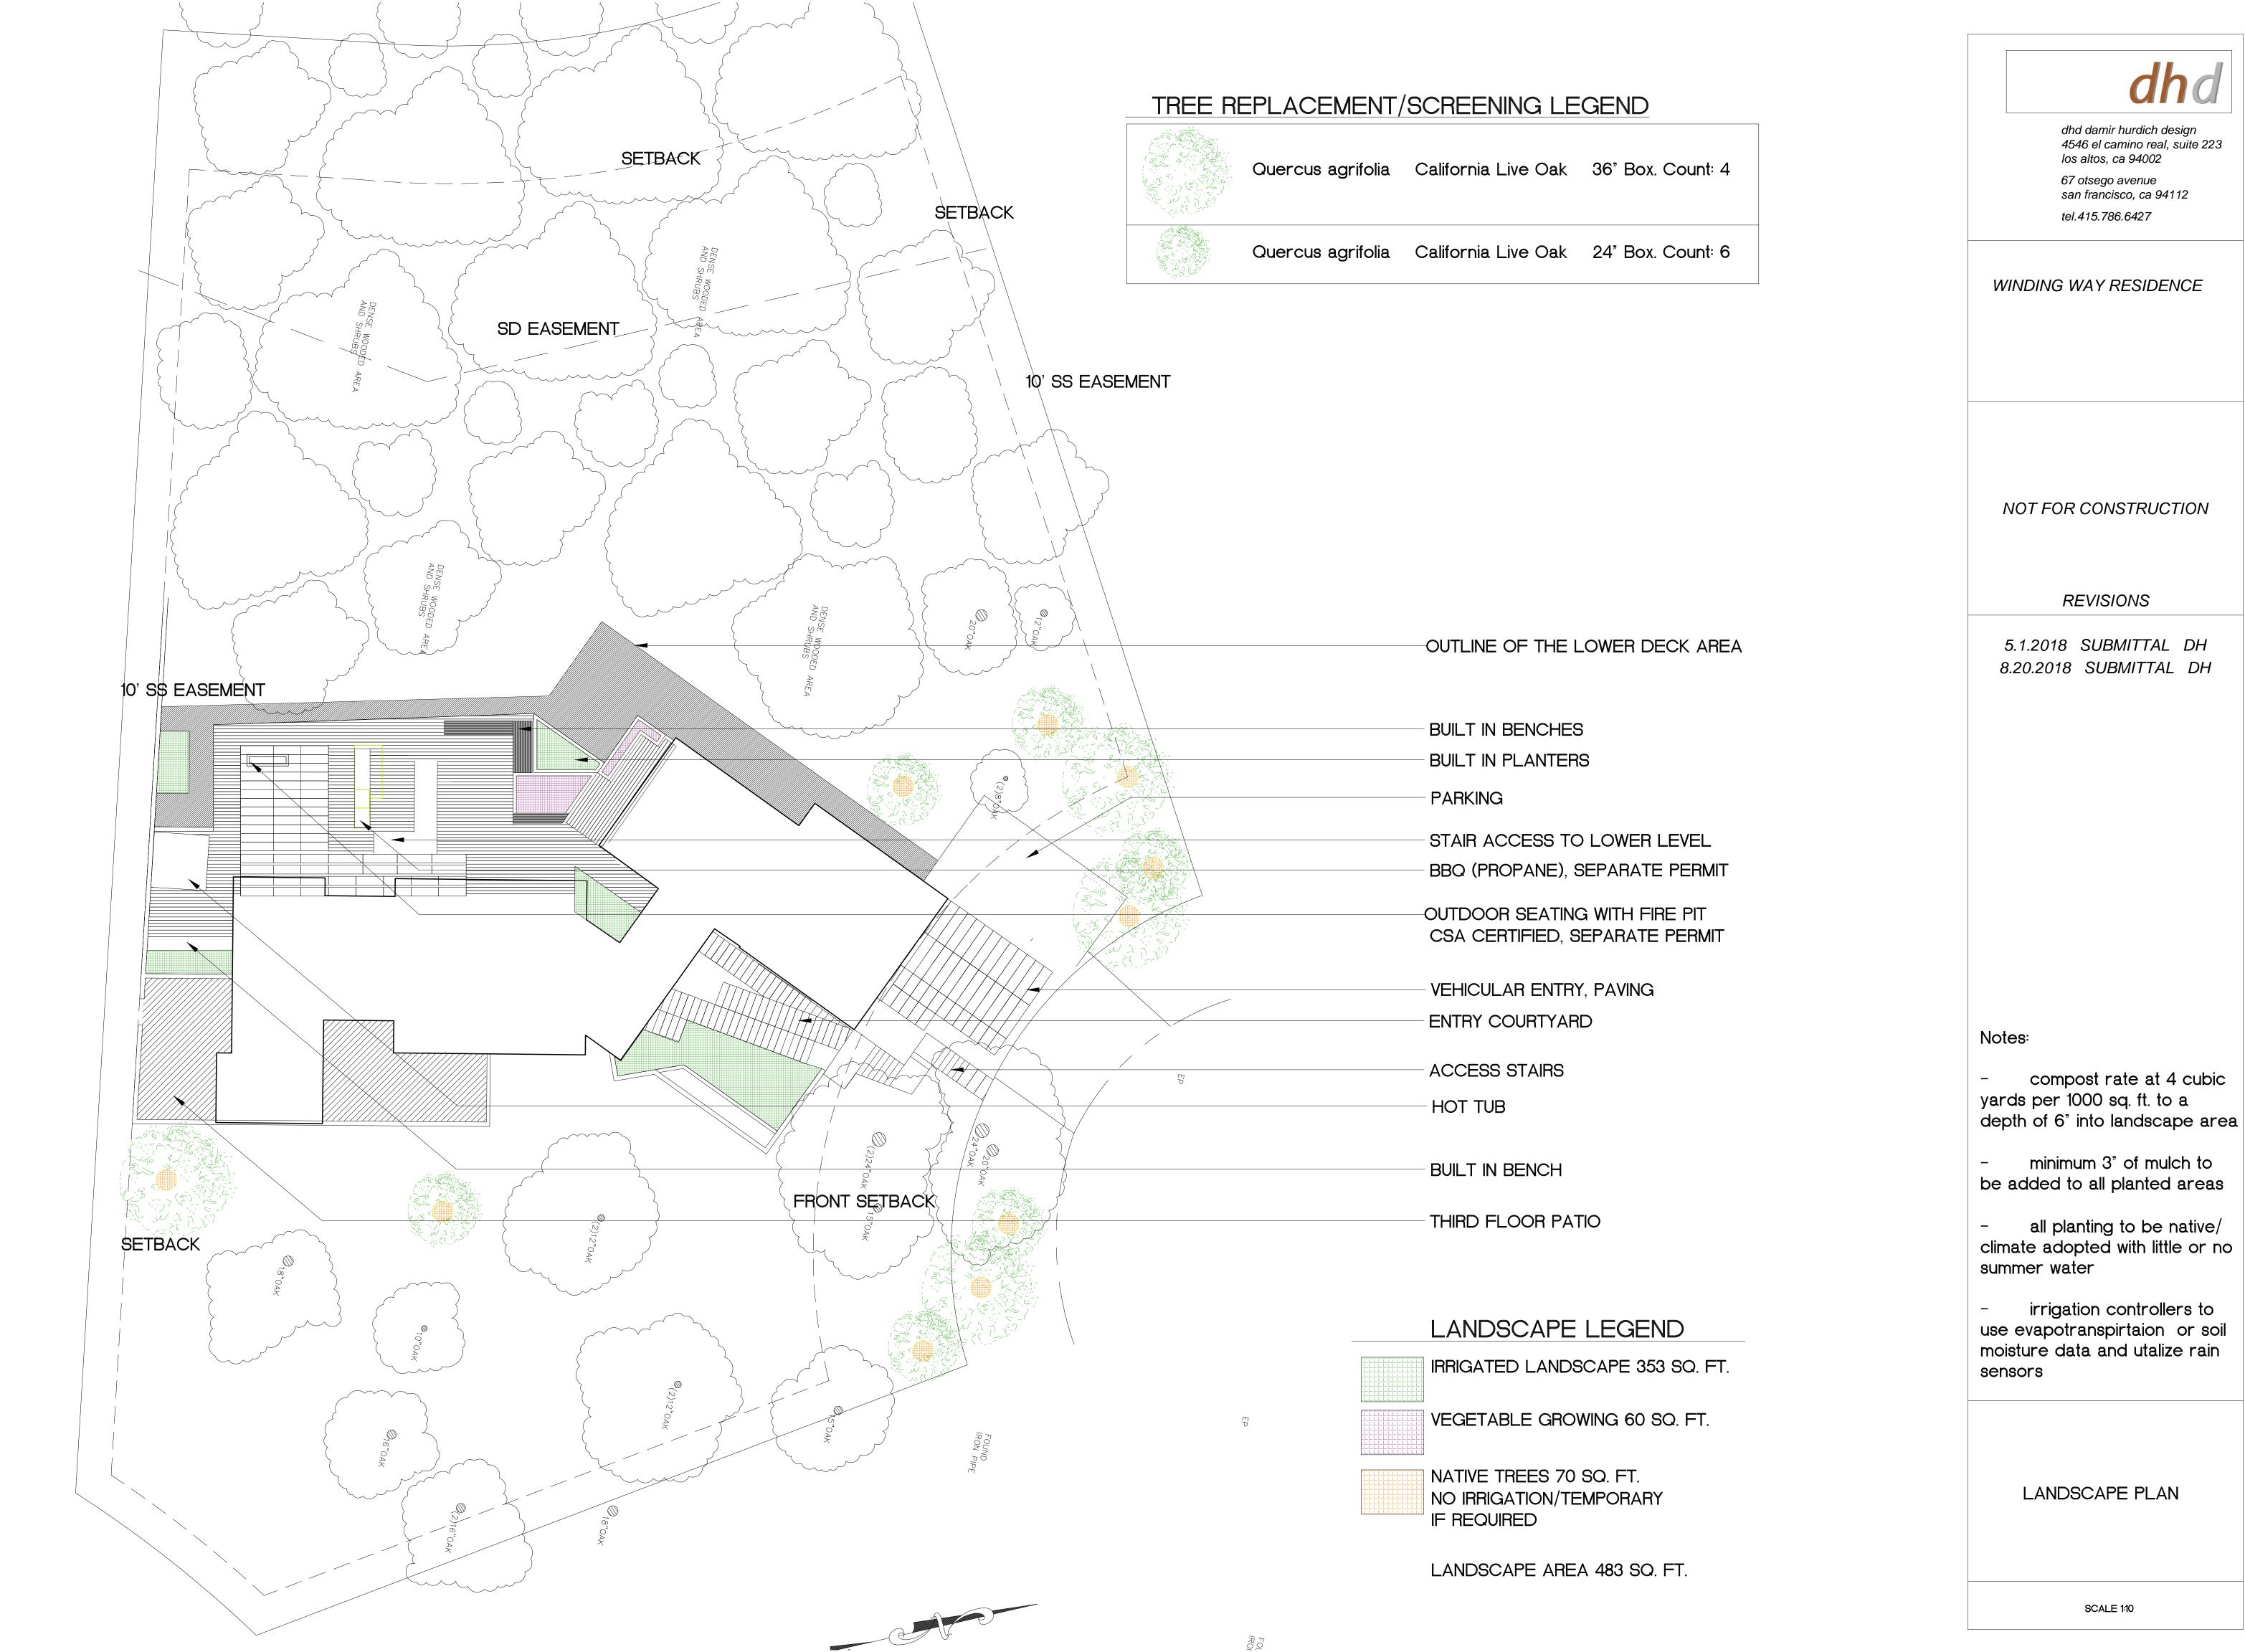



TREE REMOVAL & PROTECTION

· 1" = 10'-0"

TREE #	TYPE	TRUNK DIAMETER (in)	REMOVE	MIN TPZ RADIUS (ft.)	CONDITION	
174	Coast live oak	18	YES	N/A	POOR	
175	Coast live oak	18	YES	N/A	FAIR	
176	Buckeye	6	YES	N/A	FAIR	
177	Coast live oak	24	NO	12	GOOD	
178	Bay Laurel	12	NO	6	GOOD	
179	Coast live oak	24	NO	12	FAIR	
180	Coast live oak	24	NO	12	FAIR	
365	Coast live oak	15	YES	N/A	FAIR	
366	Coast live oak	12	YES	N/A	POOR	
367	Coast live oak	8	YES	N/A	FAIR	
368	Coast live oak	17 A nd 17	YES	N/A	FAIR	
369	Coast live oak	14	YES	N/A	FAIR	
370	Coast live oak	6 A nd 8	YES	N/A	POOR	
371	Coast live oak	18	YES	N/A	FAIR	
372	Coast live oak	18, 18, 18	NO	15	FAIR	
373	Coast live oak	17	NO	8.5	FAIR	
374	Coast live oak	45	NO	22.5	FAIR	
375	Coast live oak	18	YES	N/A	FAIR	
376	Coast live oak	24, 16 and 12	YES	N/A	FAIR	3
377	Coast live oak	15 and 13	YES	N/A	POOR	
378	Coast live oak	12	YES	N/A	POOR	
379	Coast live oak	12	YES	N/A	POOR	
380	Coast live oak	6 And 4	NO	5	FAIR	
381	Coast live oak	12	YES	N/A	DEAD	
382	Coast live oak	12 And 9	NO	6	FAIR	
383	Coast live oak	6	NO	3	GOOD	
384	Coast live oak	4	NO	2	FAIR	
385	Coast live oak	4	NO	2	FAIR	
386	Buckeye	5	NO	2.5	FAIR	
387	Coast live oak	20	NO	10	FAIR	
388	Coast live oak	8	YES	N/A	DEAD	
389	Bay Laurel	30	YES	N/A	GOOD	
390	Coast live oak	13	NO	6.5	FAIR	
391	Coast live oak	5	YES	N/A	DEAD	
392	Coast live oak	12 and 12	YES	N/A	POOR	
393	Buckeye	11	NO	5.5	FAIR	
394	Coast live oak	9	NO	4.5	FAIR	
395	Coast live oak	13	YES	N/A	POOR	
396	Coast live oak	17 And 15	NO	9	FAIR	
397	Coast live oak	10	NO	5	FAIR	
398	Coast live oak	18	NO	9	FAIR	
399	Coast live oak	8	NO	4	FAIR	
400	Coast live oak	13	NO	6.5	GOOD	
7 TREE	E REMOVA	L LIST				

VE	MIN TPZ RADIUS (ft.)	CONDITION	TOUR DRIP LINE
	N/A	POOR	TREE DRIP LINE
	N/A	FAIR	
	N/A	FAIR	
	12	GOOD	DEMO AND REMOVE
	6	GOOD	EXISTING TREE
	12	FAIR	
	12	FAIR	
	N/A	FAIR	TREE PROTECTION,
j S	N/A	POOR	AS NEEDED \
	N/A	FAIR	
	N/A	FAIR	TREE PROTECTION
	N/A	FAIR	FENCING LINE FOR TREE PROTECTION ZONE (TPZ)
	N/A	POOR	PROTECTION ZONE (TPZ)
	N/A	FAIR	NOTE
	15	FAIR	NOTE: LIMITS OF DEMOLITION ARE APPROXIMATE,
	8.5	FAIR	CONTRACTOR TO FIELD VERIIFY LIMITS PRIOR TO
	22.5	FAIR	BEGINNING OF CONSTRUCTION
ĝ	N/A	FAIR	TREE DEMO & PROTECTION LEGEND
	N/A	FAIR	3 1/2" = 1'-0"
	N/A	POOR	0.01/2 = 1.0
	N/A	POOR	
	N/A	POOR	REFER TO CIVIL DRAWINGS FOR
	5	FAIR	TREE PROTECTION DETAILS, SITE
	N/A	DEAD	·
	6	FAIR	GRADING, UTILITIES AND EROSION
	3	GOOD	CONTROL
	2	FAIR	
	2	FAIR	
	2.5	FAIR	
	10	FAIR	
	N/A	DEAD	
	N/A	GOOD	
	6.5	FAIR	
	N/A	DEAD	
	N/A	POOR	





TEISMANN CHANDRA

180 WINDING WAY SAN CARLOS, CA 94070

BLOCK/LOT:Project Number

1. A REGISTERED CONSULTING ARBORIST® OR CERTIFIED ARBORIST® IS TO BE RETAINED TO ACT AS THE PROJECT ARBORIST TO MONITOR ANY CONSTRUCTION ACTIVITIES THAT MAY IMPACT THE HEALTH OF PROTECTED TREES.

PRECONSTRUCTION MEETING WITH PROJECT ARBORIST

2. PRIOR TO BEGINNING WORK, ALL CONTRACTORS INVOLVED WITH THE PROJECT SHOULD ATTEND A PRE-CONSTRUCTION MEETING WITH THE PROJECT ARBORIST TO REVIEW THE TREE PROTECTION GUIDELINES. ACCESS ROUTES, STORAGE AREAS, AND WORK PROCEDURES WILL BE DISCUSSED.

3. SCHEDULE FOR PROJECT ARBORIST MONITORING ON A MONTHLY BASIS, AND WHEN TRENCHING NEAR PROTECTED TREES OR WORKING INSIDE THE TREE PROTECTION ZONE.

TREE PROTECTION ZONE (TPZ)

4. A SIX INCH LAYER OF CLEAN WOOD CHIPS IS TO BE INSTALLED WITHIN THE DRIPLINE OF ALL PROTECTED TREES. KEEP WOOD CHIPS 3 FEET FROM THE TRUNK.

5. TREE PROTECTION LOCATIONS SHOULD BE MARKED BEFORE ANY FENCING CONTRACTOR ARRIVES. 6. PRIOR TO THE ARRIVAL OF CONSTRUCTION EQUIPMENT OR MATERIALS ON SITE, SIX-FOOT HIGH CHAIN LINK FENCE

MOUNTED ON 8-FEET TALL, 2-INCH DIAMETER METAL POSTS, DRIVEN 2 FEET INTO THE GROUND AND SPACED NO MORE THAN 10 FEET APART SHALL BE ERECTED AT THE LIMITS OF EACH TREE PROTECTION ZONE (TPZ).

7. ONCE ESTABLISHED, THE FENCE MUST REMAIN UNDISTURBED AND BE MAINTAINED THROUGHOUT THE CONSTRUCTION PROCESS UNTIL FINAL INSPECTION. THE FENCE SHOULD BE MAINTAINED THROUGHOUT THE SITE DURING THE CONSTRUCTION PERIOD AND SHOULD BE INSPECTED PERIODICALLY FOR DAMAGE AND PROPER FUNCTION. 8. LAMINATED WARNING SIGNS, MINIMUM SIZE 8.5" X 11", STATING THAT ALL AREAS WITHIN THE FENCING ARE TREE

PROTECTION ZONES AND THAT DISTURBANCE IS PROHIBITED ARE TO BE ATTACHED. SIGNS SHOULD BE SPACED NO MORE THAN 10 FEET APART. TEXT ON THE SIGNS SHOULD BE IN BOTH ENGLISH AND SPANISH (APPENDIX D). 9. THE AREA WITHIN THE FENCING IS THE TREE PROTECTION ZONE (TPZ). 10. TPZ FENCING MAY ONLY BE ONLY BE MOVED, CROSSED, OR ALTERED WITH PERMISSION OF THE PROJECT ARBORIST.

11. TREE PROTECTION ZONE (TPZ) RESTRICTIONS A. NO OPERATION, STORAGE, OR PARKING OF VEHICLES OR HEAVY B. NO STORAGE OR DISPOSAL OF BUILDING MATERIALS, REFUSE, SOIL, EXCAVATED SPOILS, OR CHEMICALS OF ANY KIND.

C. NO CUTTING OF TREE ROOTS BY UTILITY TRENCHING, FOUNDATION DIGGING, OR ANY MISCELLANEOUS EXCAVATION WITHOUT PRIOR APPROVAL OF THE PROJECT ARBORIST. D. NO USE OF TPZ AS A REST/LUNCH/BREAK AREA BY PROJECT STAFF.

E. NO GRADE CHANGES OF ANY KIND, EXCEPT AS EXPRESSLY DESIGNED OR APPROVED BY THE PROJECT ARBORIST.

F. NO ALTERATION OR DISTURBANCE, FOR ANY DURATION, OF THE GROUND INSIDE THE TPZ. 12. ALL WORK WITHIN THE TPZ IS TO BE APPROVED BY THE PROJECT ARBORIST PRIOR TO COMMENCEMENT OF THE TASK.

GRADING LIMITATIONS 13. GRADE CHANGES OUTSIDE OF THE TPZ SHALL NOT SIGNIFICANTLY ALTER DRAINAGE TO ANY TREE.

14. GRADE CHANGES UNDER SPECIFICALLY APPROVED CIRCUMSTANCES SHALL NOT ALLOW MORE THAN 6- INCHES OF FILL SOIL ADDED OR ALLOW MORE THAN 4-INCHES OF EXISTING SOIL TO BE REMOVED FROM NATURAL GRADE UNLESS

15. GRADE CUTS EXCEEDING 4-INCHES SHALL INCORPORATE RETAINING WALLS OR AN APPROPRIATE TRANSITION EQUIVALENT.

ROOT PRUNING AND TRENCHING

16. ROOTS OVER 1 INCH IN DIAMETER SHOULD BE PRUNED, RATHER THAN CRUSHED OR TORN. PRUNE ROOTS CLEAN AND SQUARE AT UNDAMAGED TISSUE USING HAND PRUNERS OR A SAW. 17. ROOTS 2 INCHES AND GREATER MUST REMAIN INJURY FREE. 18. IF PRUNING OF ROOTS 2 INCHES OR GREATER IS UNAVOIDABLE, THIS PRUNING MUST BE MONITORED AND DOCUMENTED

BY THE PROJECT ARBORIST OR A QUALIFIED ISA CERTIFIED ARBORIST. 19. ROOTS SHOULD BE CUT BEYOND SINKER ROOTS OR OUTSIDE ROOT BRANCH JUNCTIONS. ONCE SEVERED, EXPOSED ROOTS AND UPPER 3 FEET OF TRENCH WALLS SHOULD BE KEPT MOIST WITH SEVERAL LAYERS OF BURLAP, OR BACKFILLED

WITHIN ONE HOUR. 20. ANY TRENCHING, CONSTRUCTION OR DEMOLITION THAT IS EXPECTED TO DAMAGE OR ENCOUNTER TREE ROOTS 2 INCHES 180 WINDING WAY OR GREATER, OR INSIDE THE TPZ, SHOULD BE MONITORED AND DOCUMENTED BY THE PROJECT ARBORIST OR A QUALIFIED ISA CERTIFIED ARBORIST.

EXCAVATION

21. EXCAVATION, DEMOLITION OR EXTRACTION OF MATERIAL SHALL BE PERFORMED BY EQUIPMENT SITTING OUTSIDE THE TPZ. OTHER METHODS PERMITTED ARE HAND DIGGING, HYDRAULIC OR PNEUMATIC AIR EXCAVATION TECHNOLOGY. 22. AVOID EXCAVATION WITHIN THE TPZ DURING HOT, DRY WEATHER.

23. IF EXCAVATION OR TRENCHING FOR DRAINAGE, UTILITIES, IRRIGATION LINES, ETC., IT IS THE DUTY OF THE CONTRACTOR

TO TUNNEL UNDER ANY ROOTS 2 INCHES OR GREATER IN DIAMETER.

24. BORING MACHINES SHOULD BE SET UP OUTSIDE THE DRIP LINE OR ESTABLISHED TREE PROTECTION ZONE. BORING MAY ALSO BE PERFORMED BY DIGGING A TRENCH ON BOTH SIDES OF THE TREE UNTIL ROOTS ONE INCH IN DIAMETER ARE ENCOUNTERED AND THEN HAND DUG OR EXCAVATED WITH AN AIR SPADE® OR SIMILAR AIR OR WATER EXCAVATION TOOL. BORE HOLES SHOULD BE ADJACENT TO THE TRUNK AND NEVER GO DIRECTLY UNDER THE MAIN STEM TO AVOID OBLIQUE (HEART) ROOTS. BORE HOLES SHOULD BE A MINIMUM OF THREE FEET DEEP.

SAFETY STANDARDS.

25. IF THE CONSTRUCTION IS TO OCCUR DURING THE SUMMER MONTHS SUPPLEMENTAL WATERING AND BARK BEETLE TREATMENTS SHOULD BE APPLIED TO HELP ENSURE SURVIVAL DURING AND AFTER CONSTRUCTION.

TREE PRUNING AND REMOVAL OPERATIONS 26. ALL TREE PRUNING OR REMOVALS SHOULD BE PERFORMED BY A QUALIFIED ARBORIST WITH A C-61/D-49 CALIFORNIA CONTRACTORS LICENSE.

27. TREE PRUNING SHOULD BE SPECIFIED ACCORDING TO ANSI A-300A PRUNING STANDARDS AND ADHERE TO ANSI Z133.1

28. TREES THAT NEED TO BE REMOVED OR PRUNED SHOULD BE IDENTIFIED IN THE PRE-CONSTRUCTION WALK THROUGH. POST-CONSTRUCTION PHASE

29. MONITOR THE HEALTH AND STRUCTURE OF ALL TREES FOR ANY CHANGES IN CONDITION. 30. MANAGE SOIL MOISTURE AND MAINTAIN MULCH WHERE APPLICABLE

31. PERFORM ANY OTHER MITIGATION MEASURES TO HELP ENSURE LONG TERM SURVIVAL.

Rev Description Date

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Tree Protection Plan

TREE PROTECTION GUIDELINES

1/2" = 1'-0"





180 WINDING WAY SAN CARLOS, CA 94070

BLOCK/LOT:Project Number

PROJECT NOTES:

BUILDING IS LOCATED IN AN LRA HIGH FIRE HASARD SEVERITY ZONE. ALL EXTERIOR MATERIALS AND CONSTRUCTION METHODS SHALL MEET EXTERIOR WILDFIRE EXPOSURE STANDARDS.

1 Revision 1 8/2/18 Comments Rev Description Date

180 WINDING WAY

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Site Plan

Sheet Title










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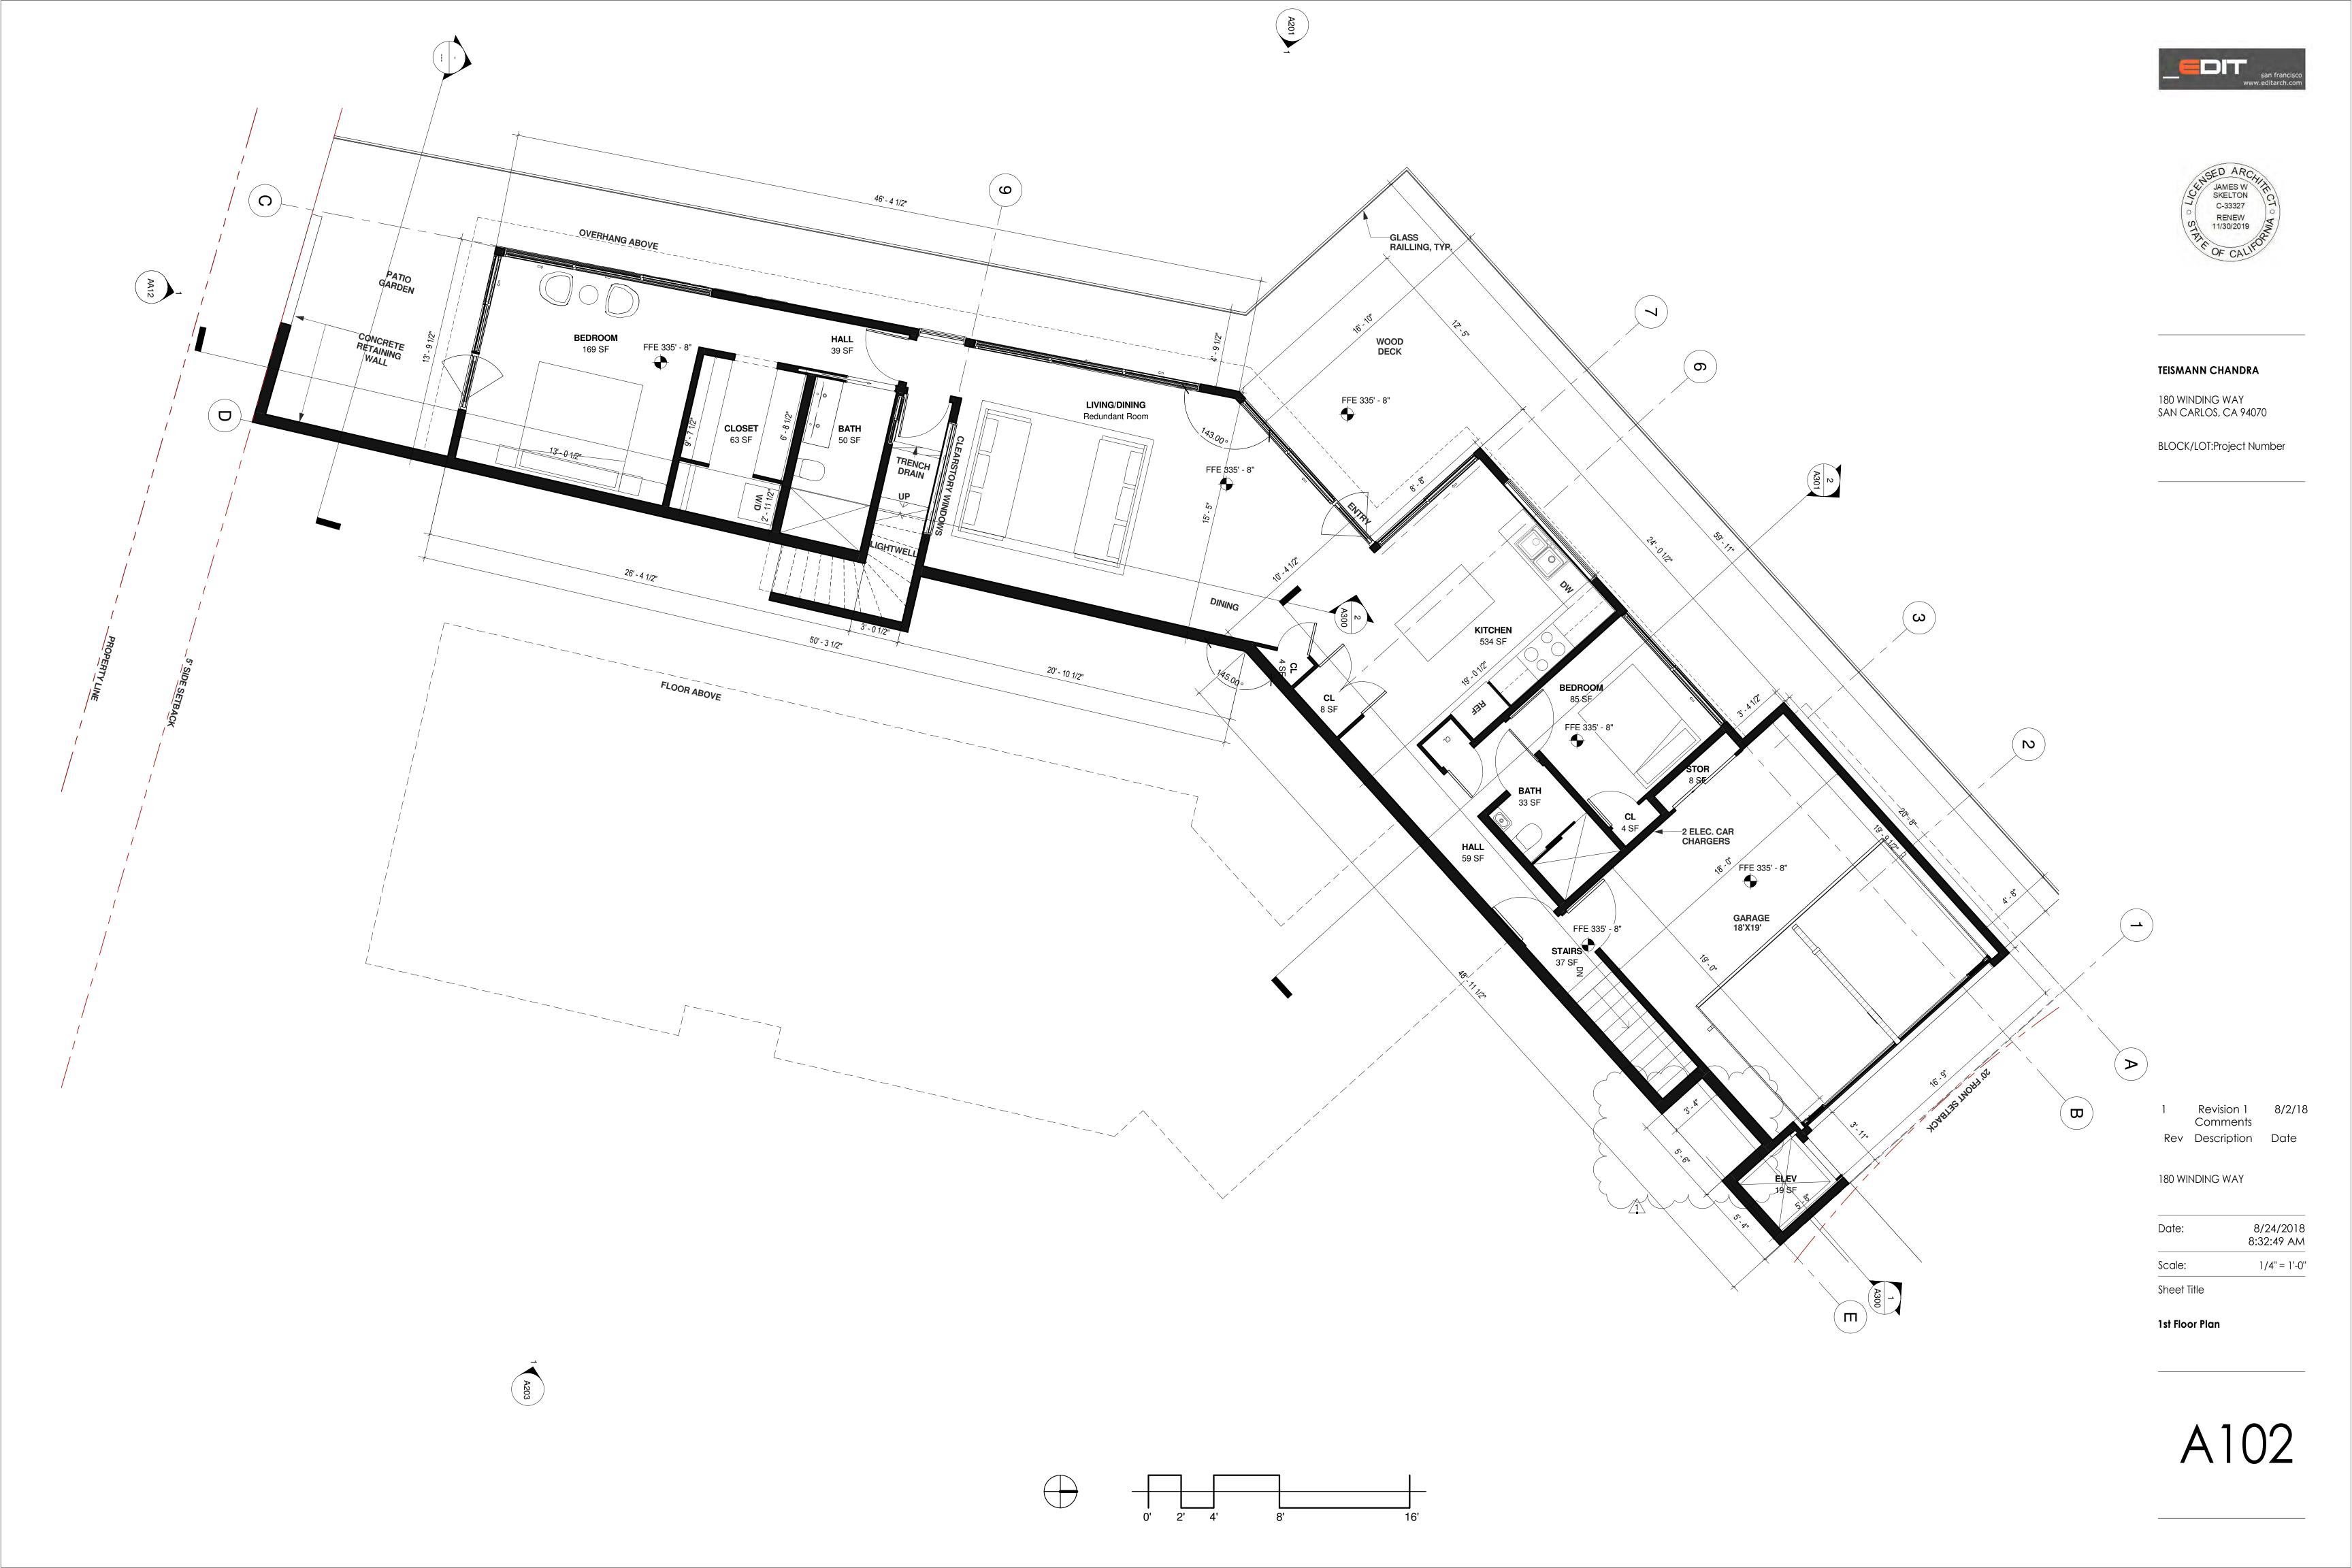



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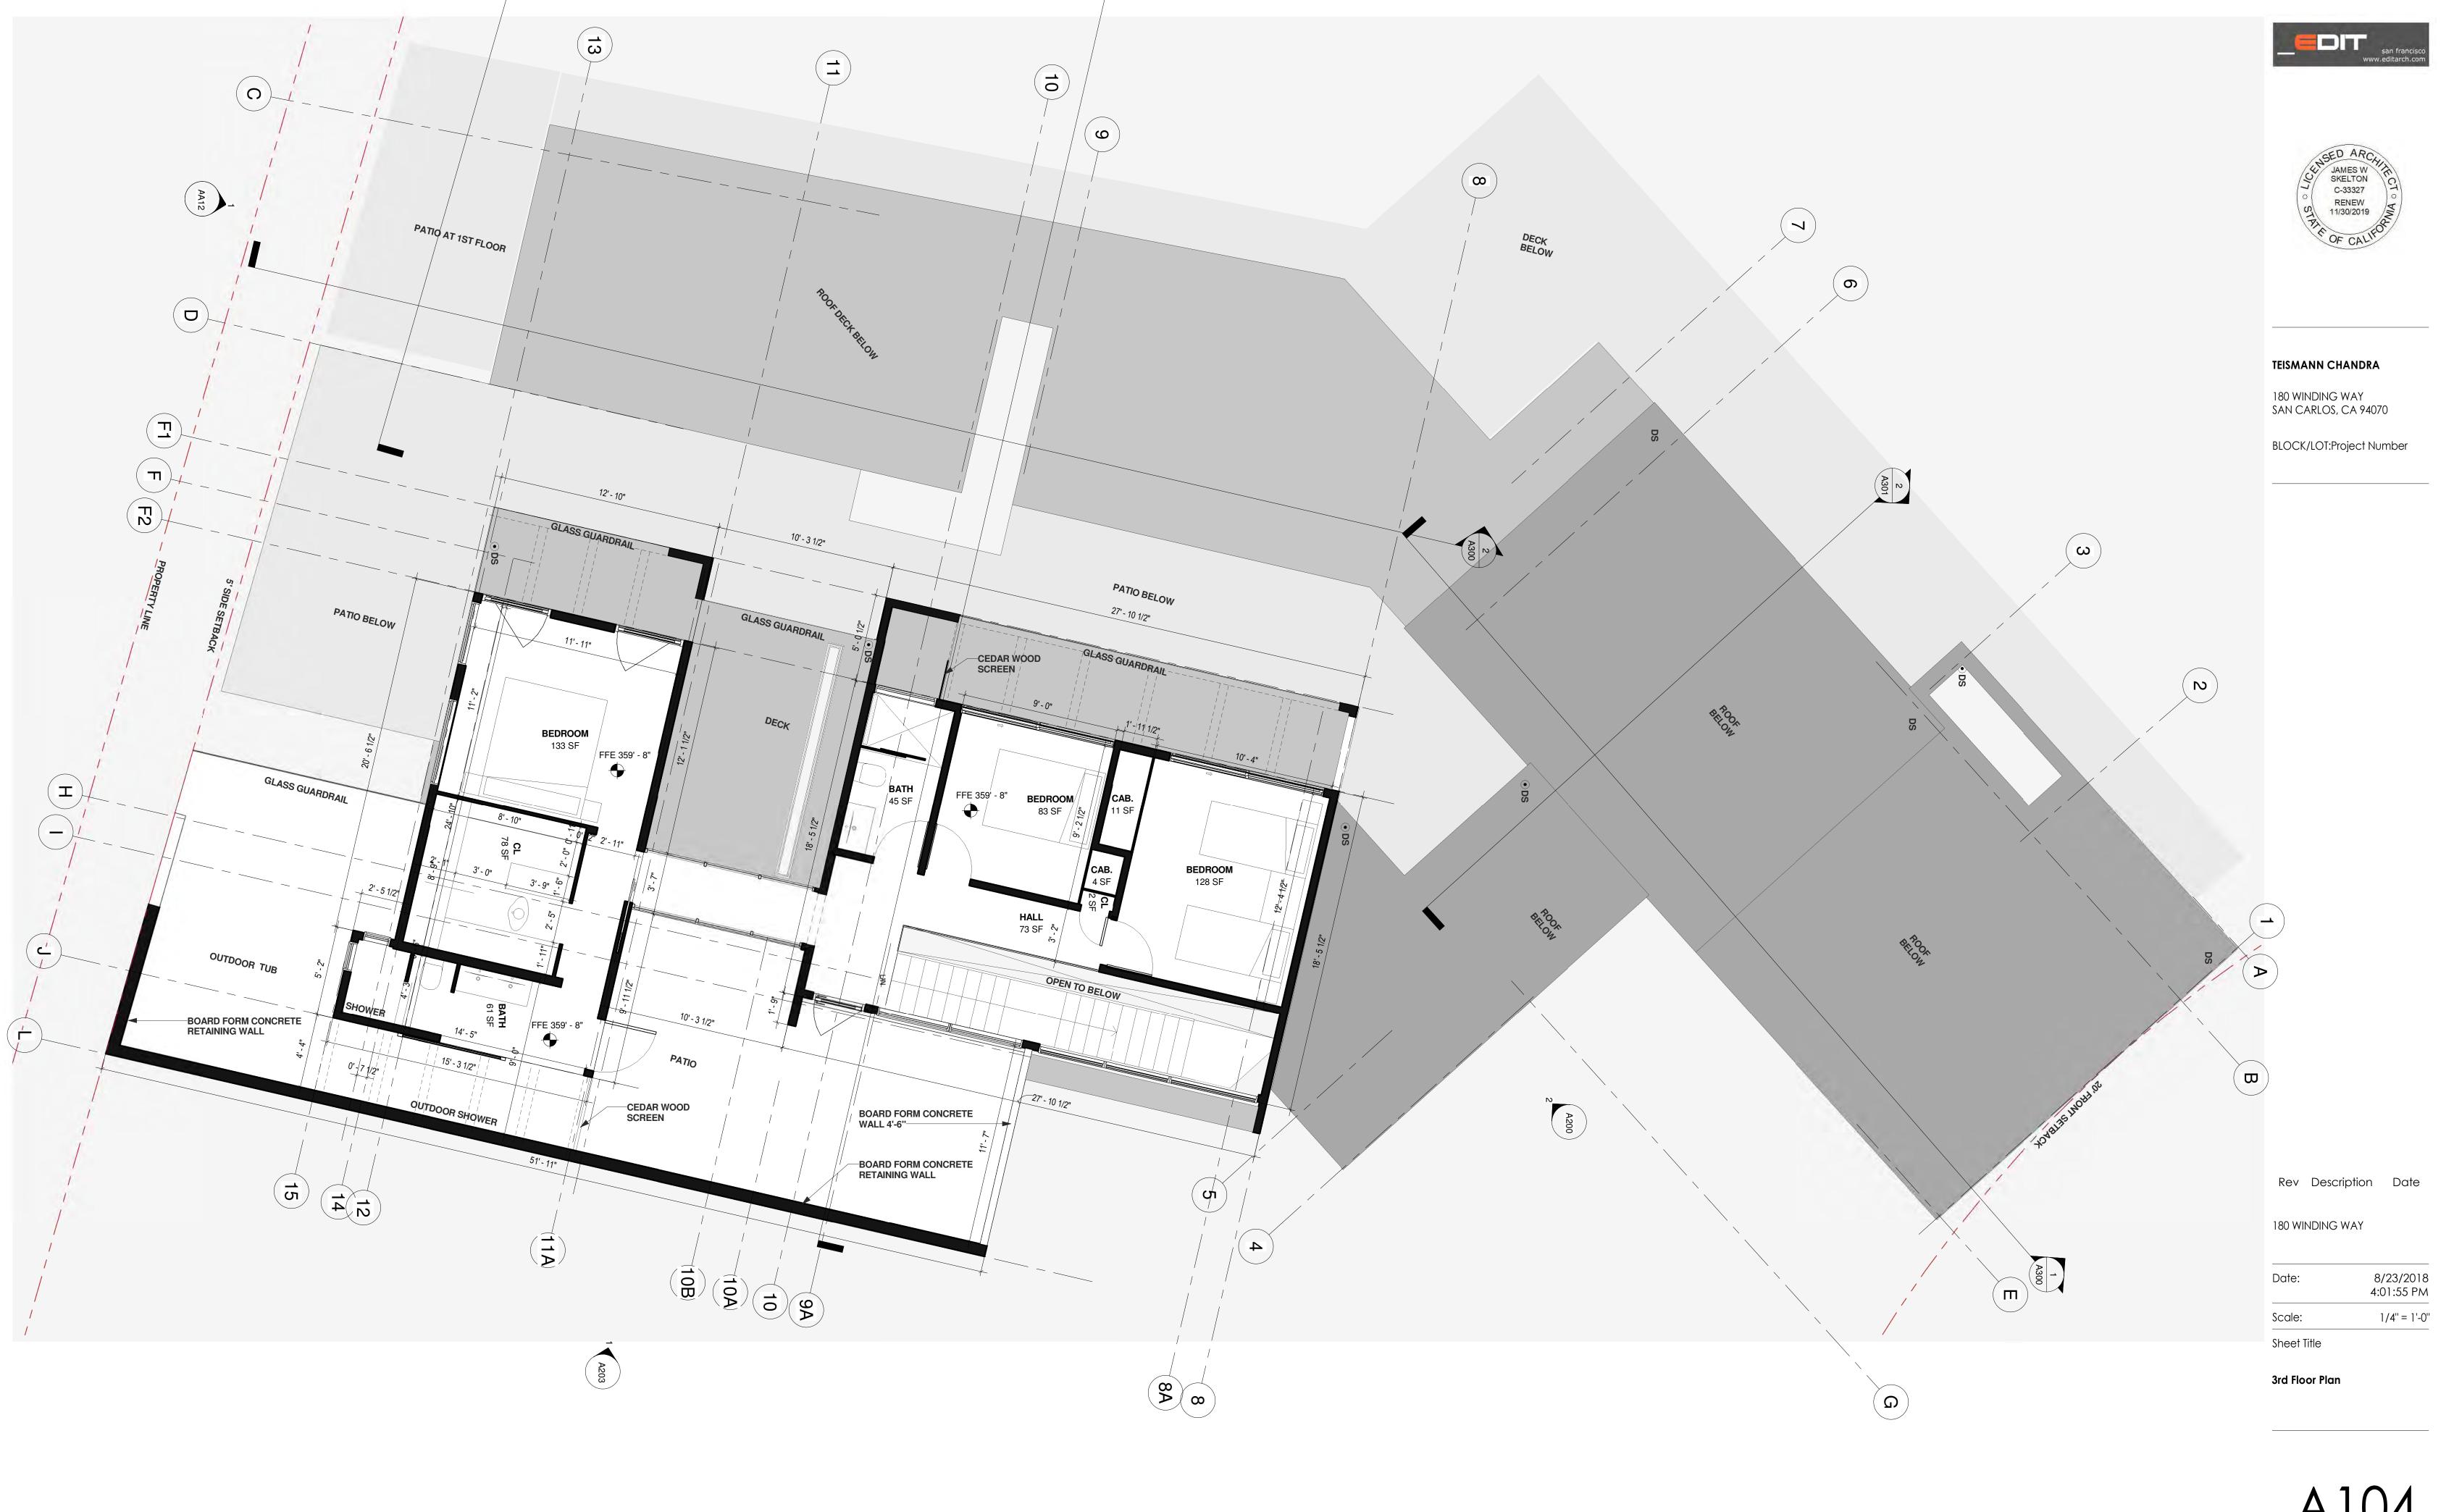
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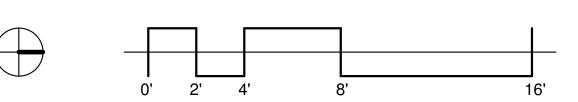
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Basement Floor Plan

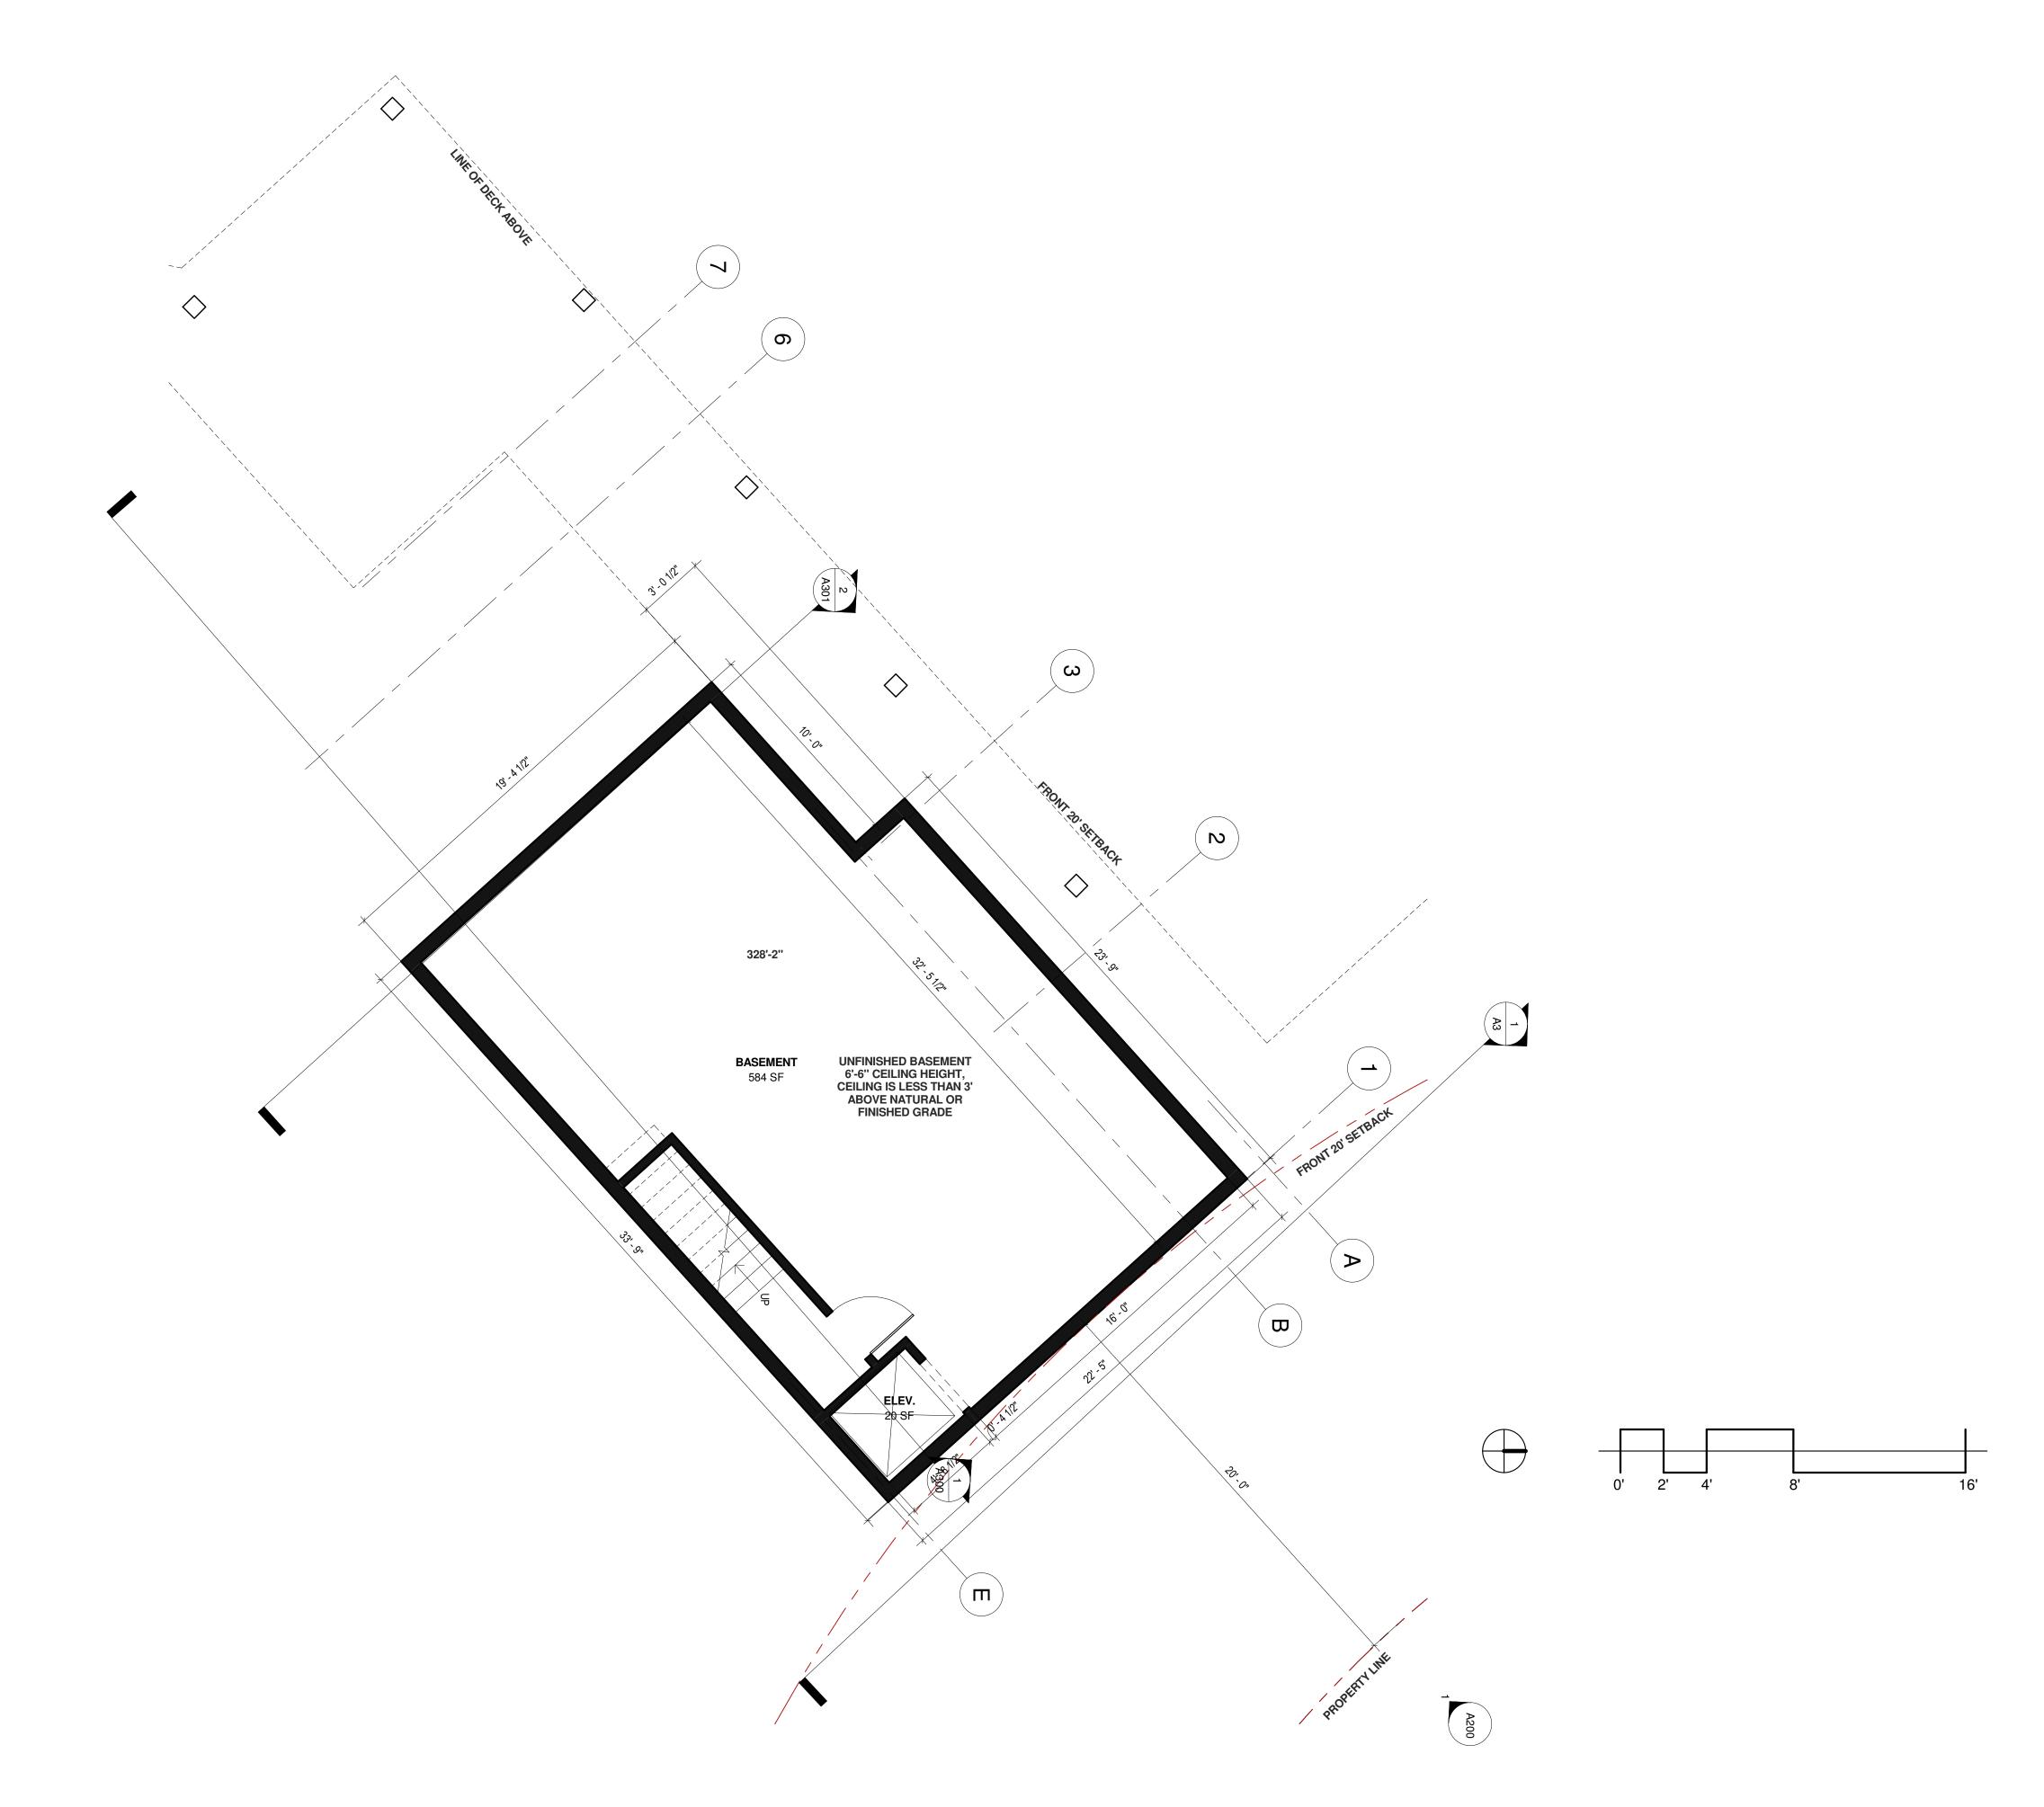








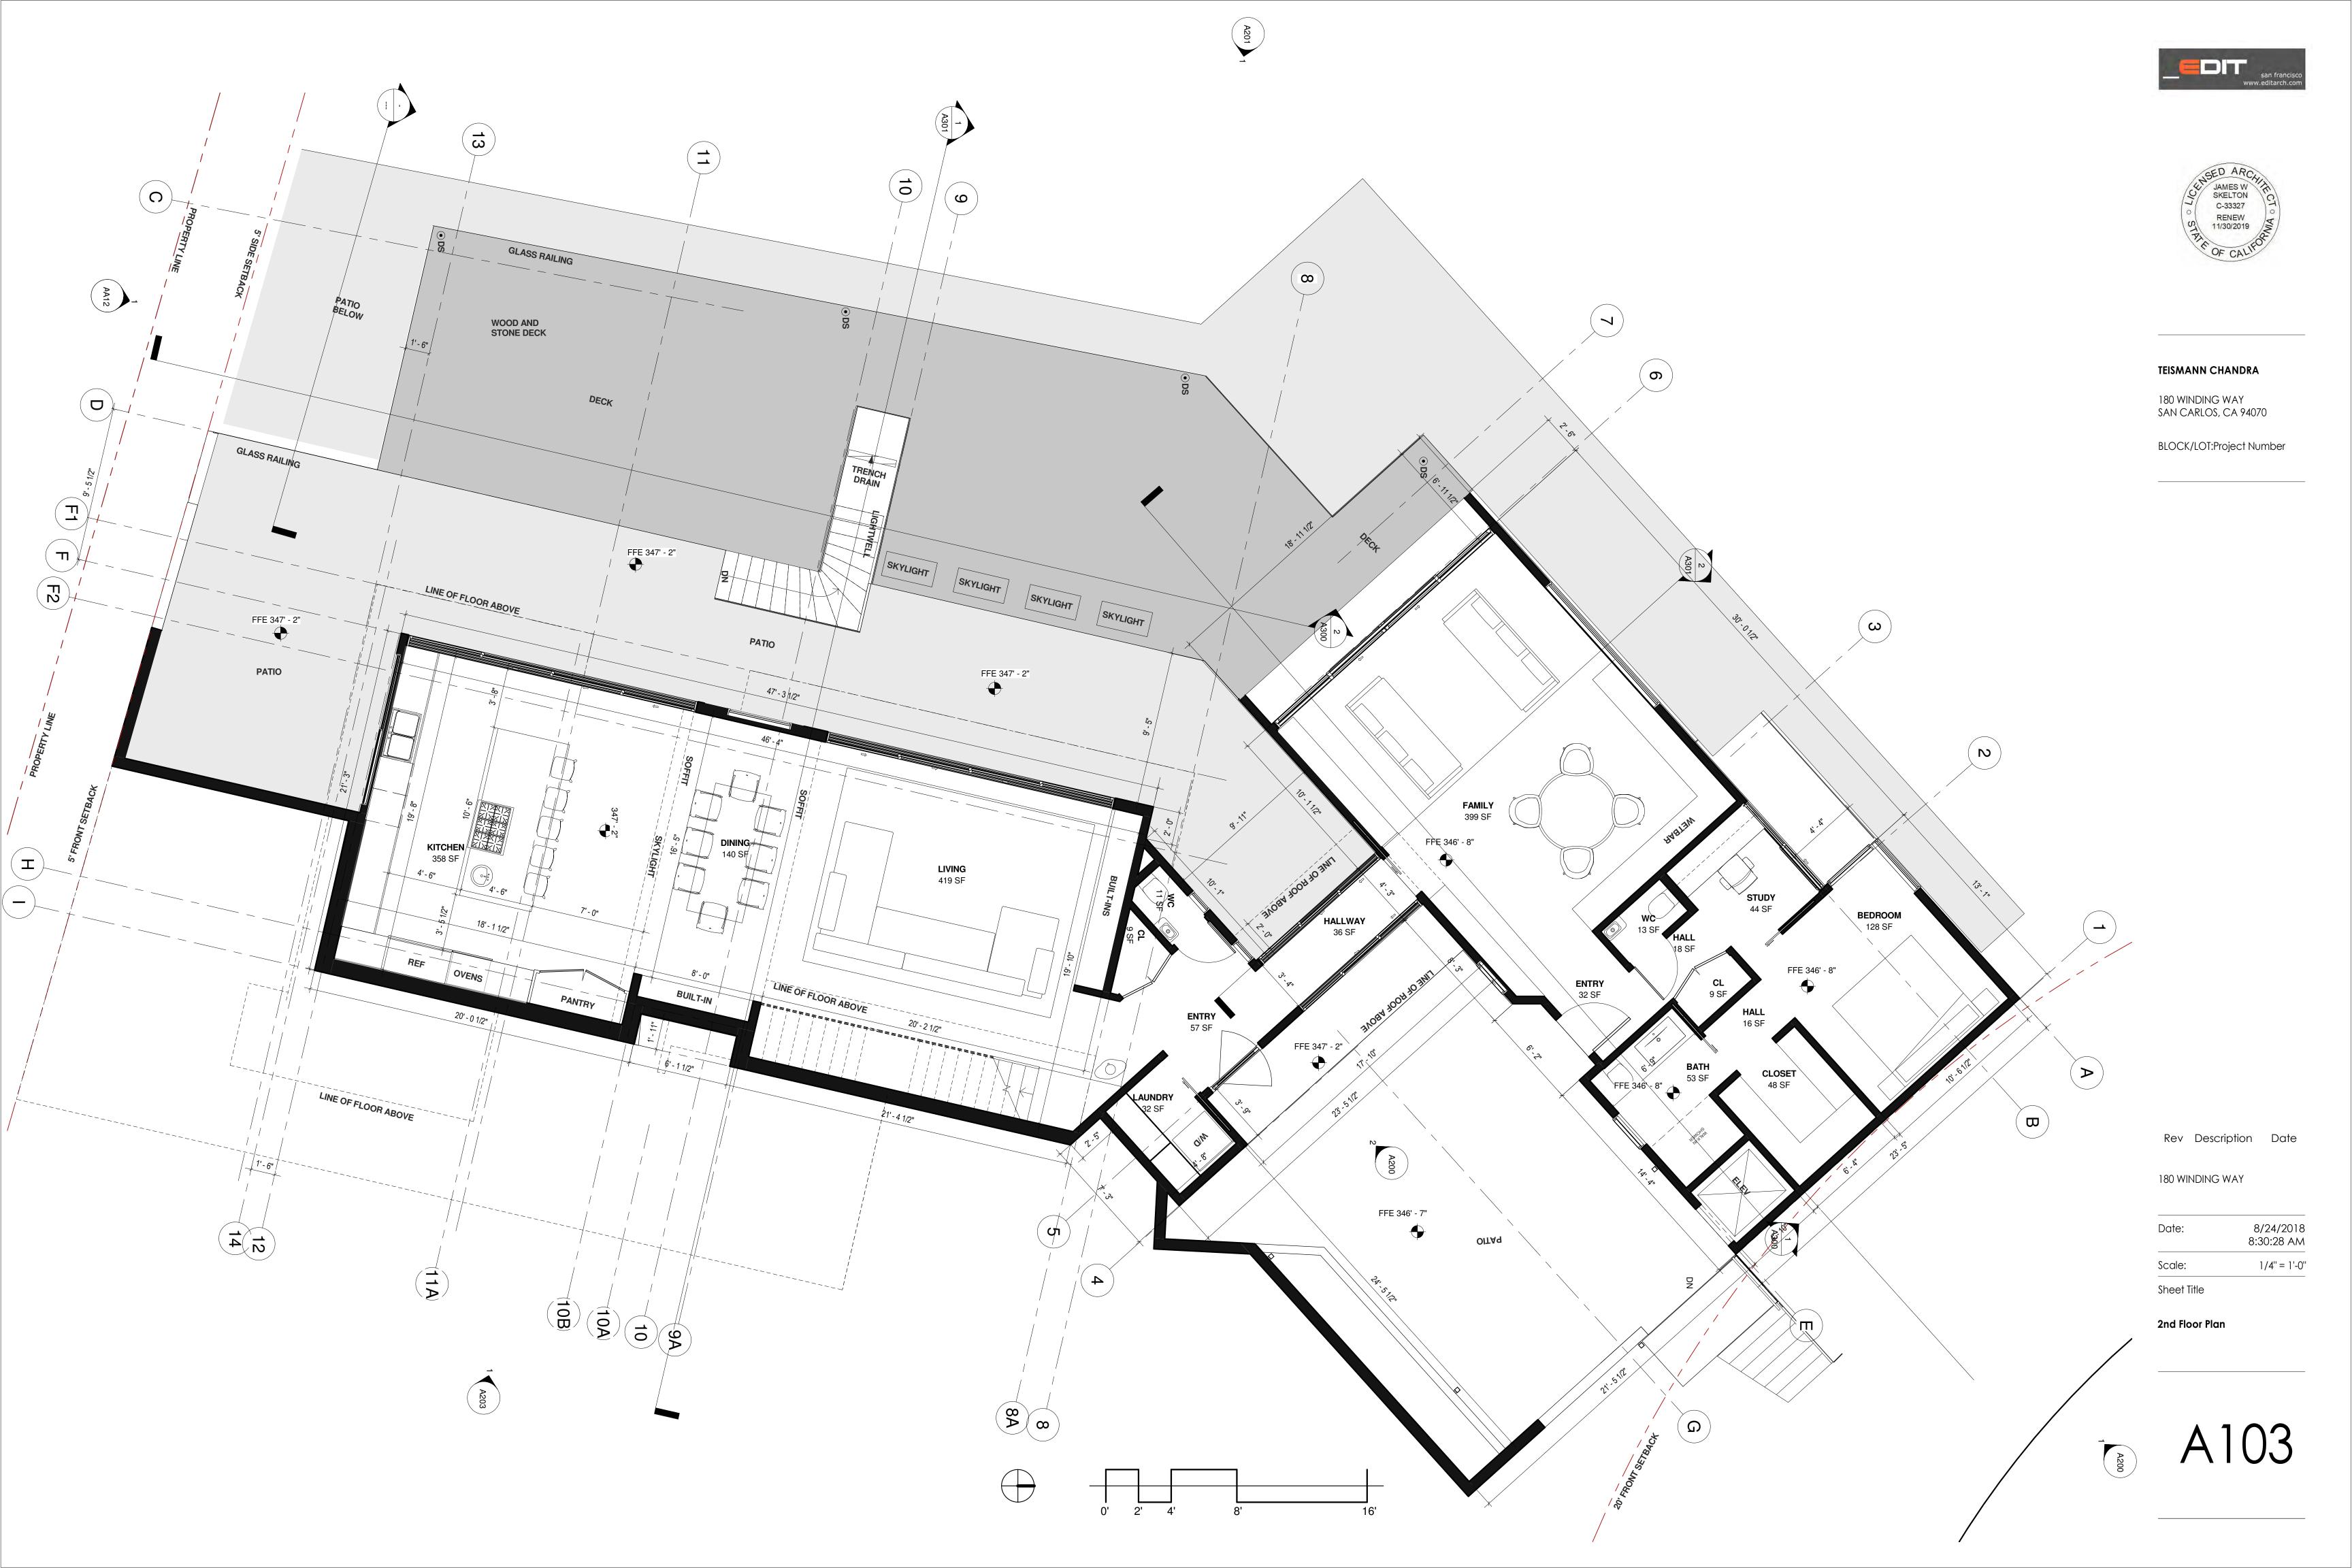



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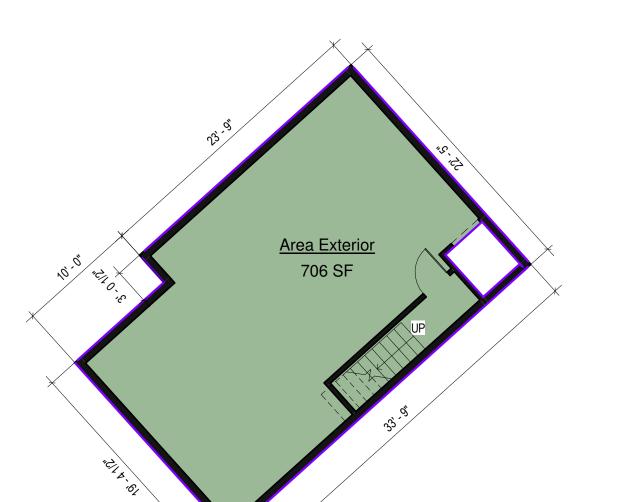
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Comments
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Roof Plan



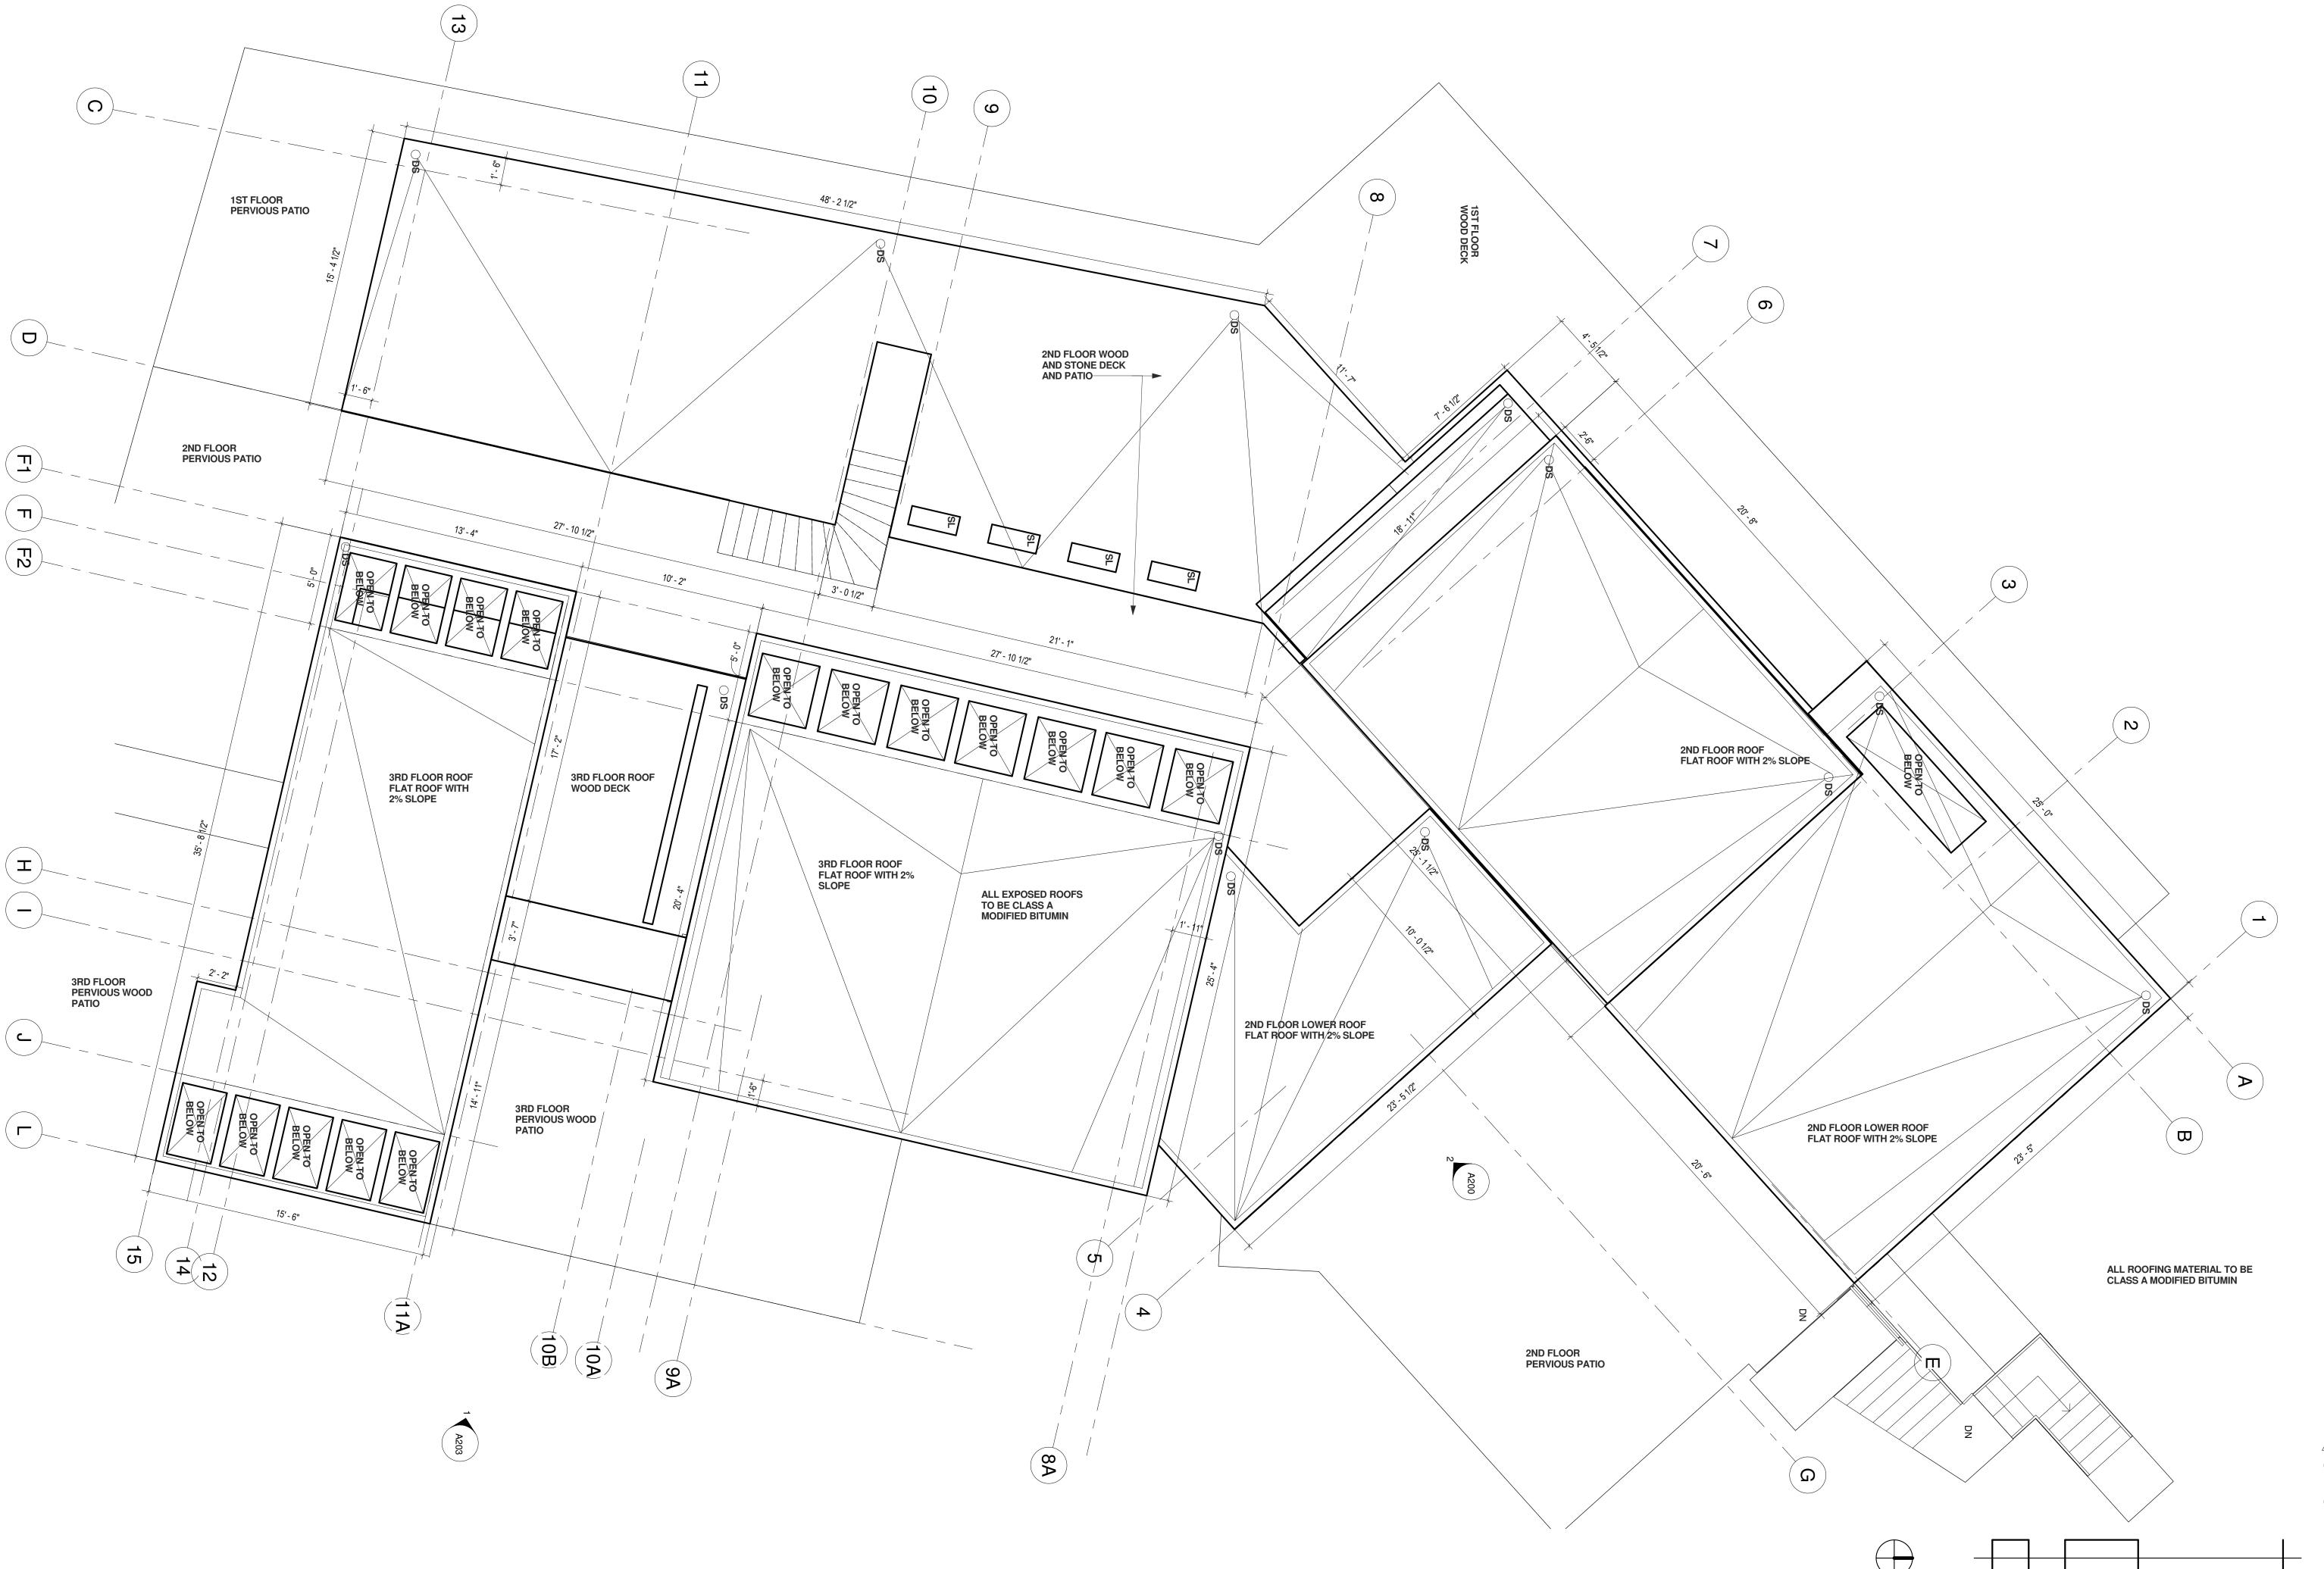

Level	Comments	Area
0 BASEMENT	BASEMENT	706 SF
1st FLOOR	GARAGE	447 SF
1st FLOOR	SECONDARY DWELLING	1200 SF
2nd FLOOR	MAIN LIVING AREA	2065 SF
3rd FLOOR	MAIN LIVING AREA	786 SF
TOTAL: 5		5204 SF
BUILDING AREATOTAL	5203 - BASEMENT (706) - GARAGE (400)	4098 SF






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1 0 BASEMENT 1/8" = 1'-0"

2 1st FLOOR 1/8" = 1'-0"





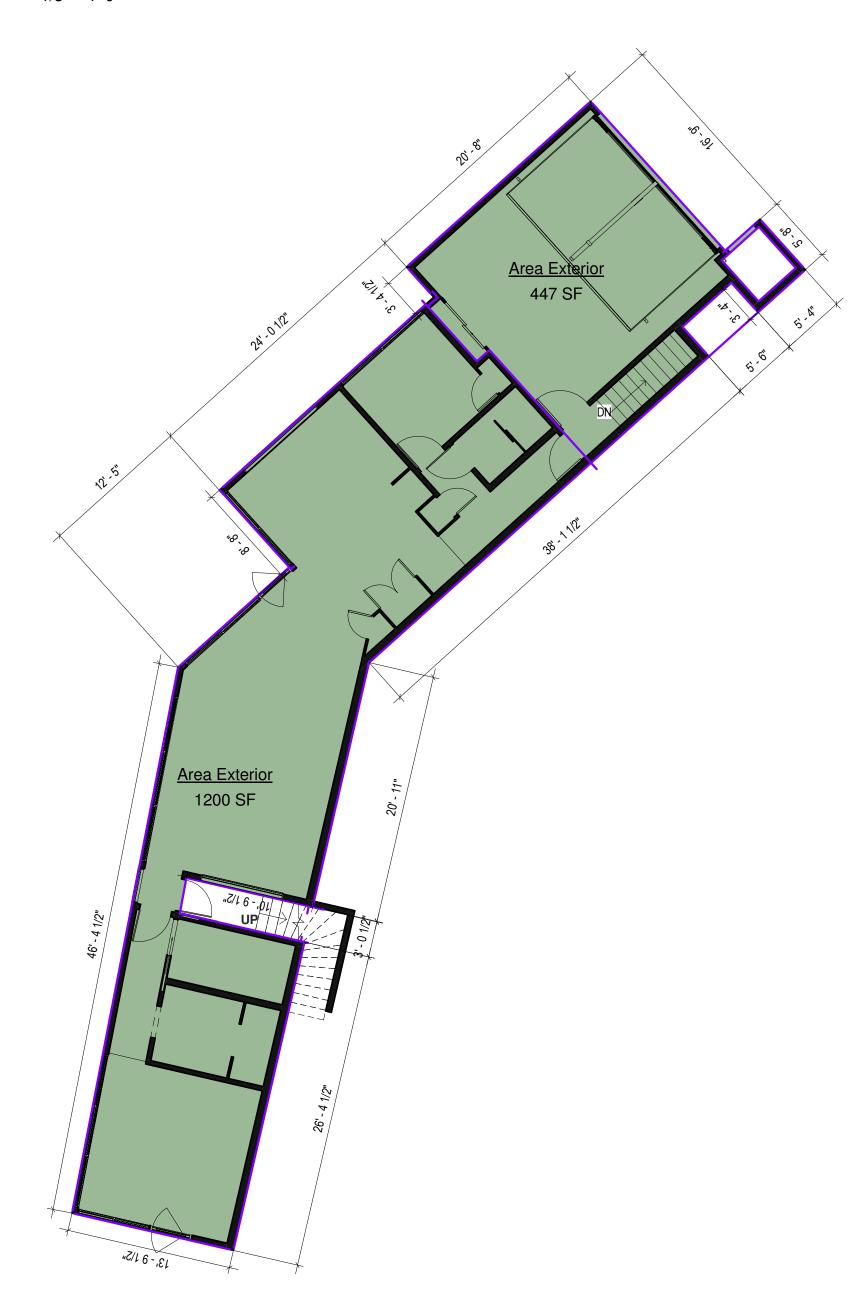


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Comments
Rev Description Date


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Building Area Calculations



4 3rd FLOOR 1/8" = 1'-0"

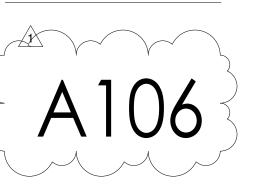

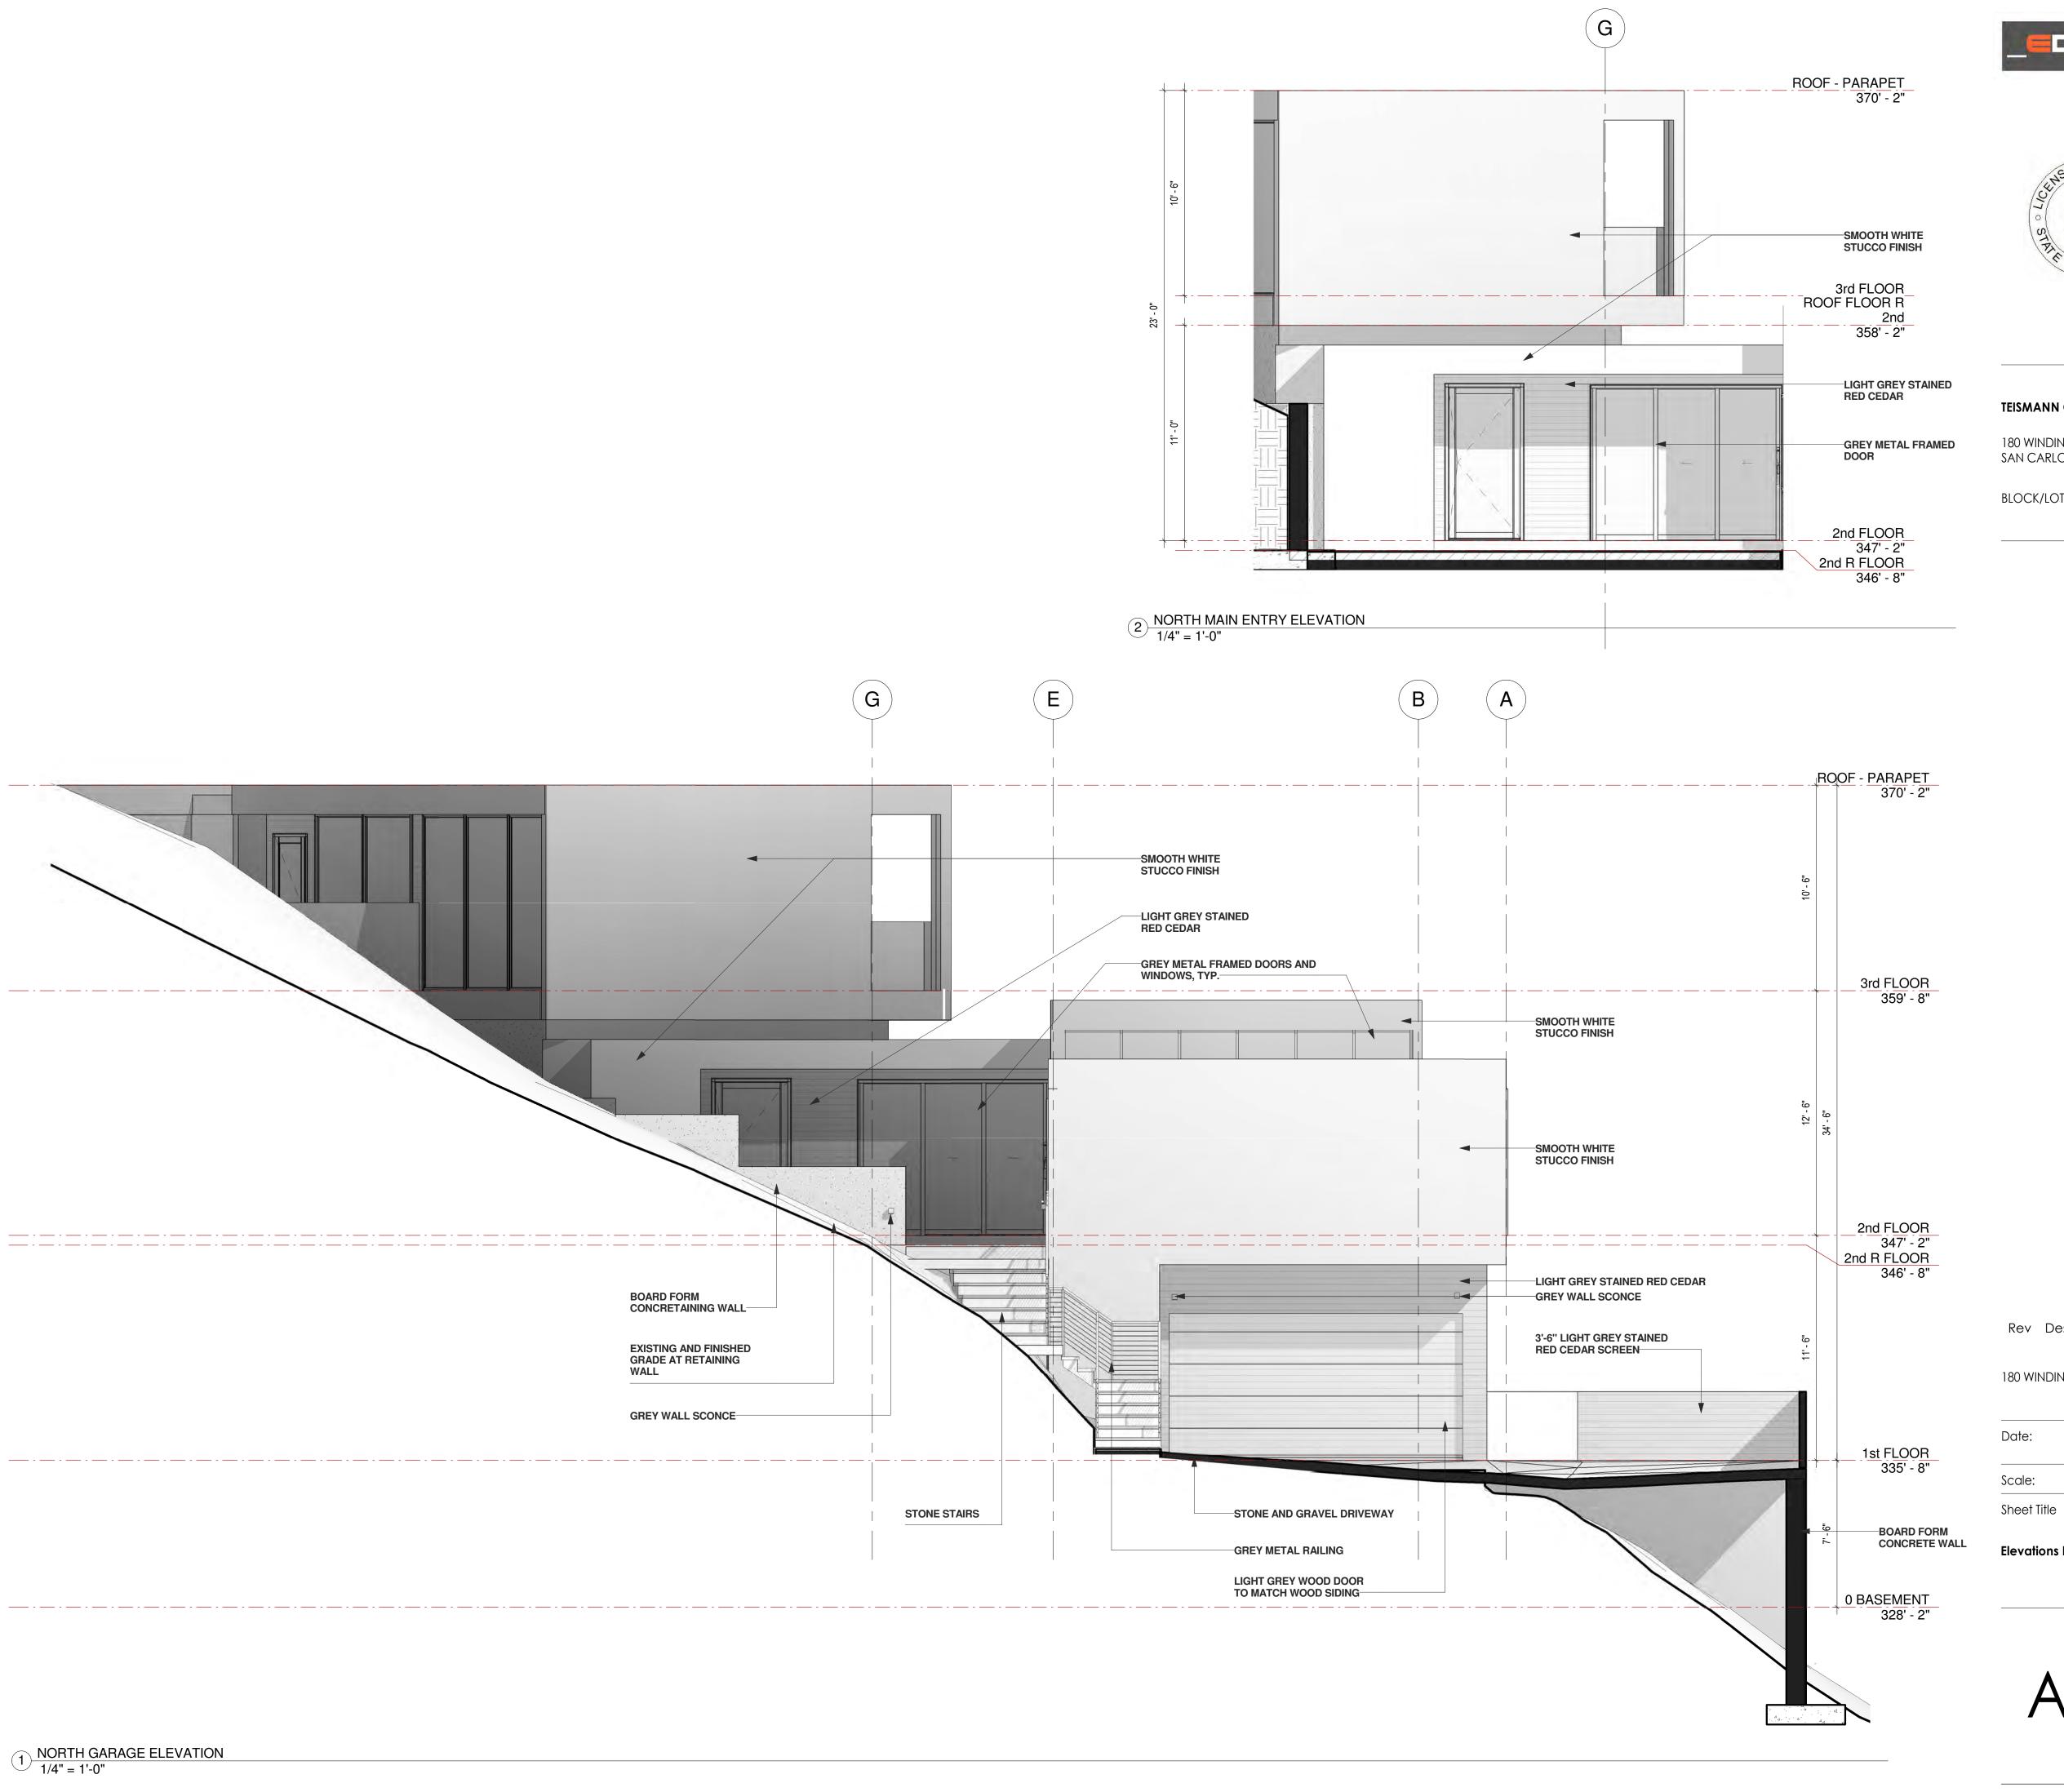

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180 WINDING WAY

8/23/2018 4:05:06 PM Scale: 1/4" = 1'-0"


Elevations North





180 WINDING WAY SAN CARLOS, CA 94070

BLOCK/LOT:Project Number

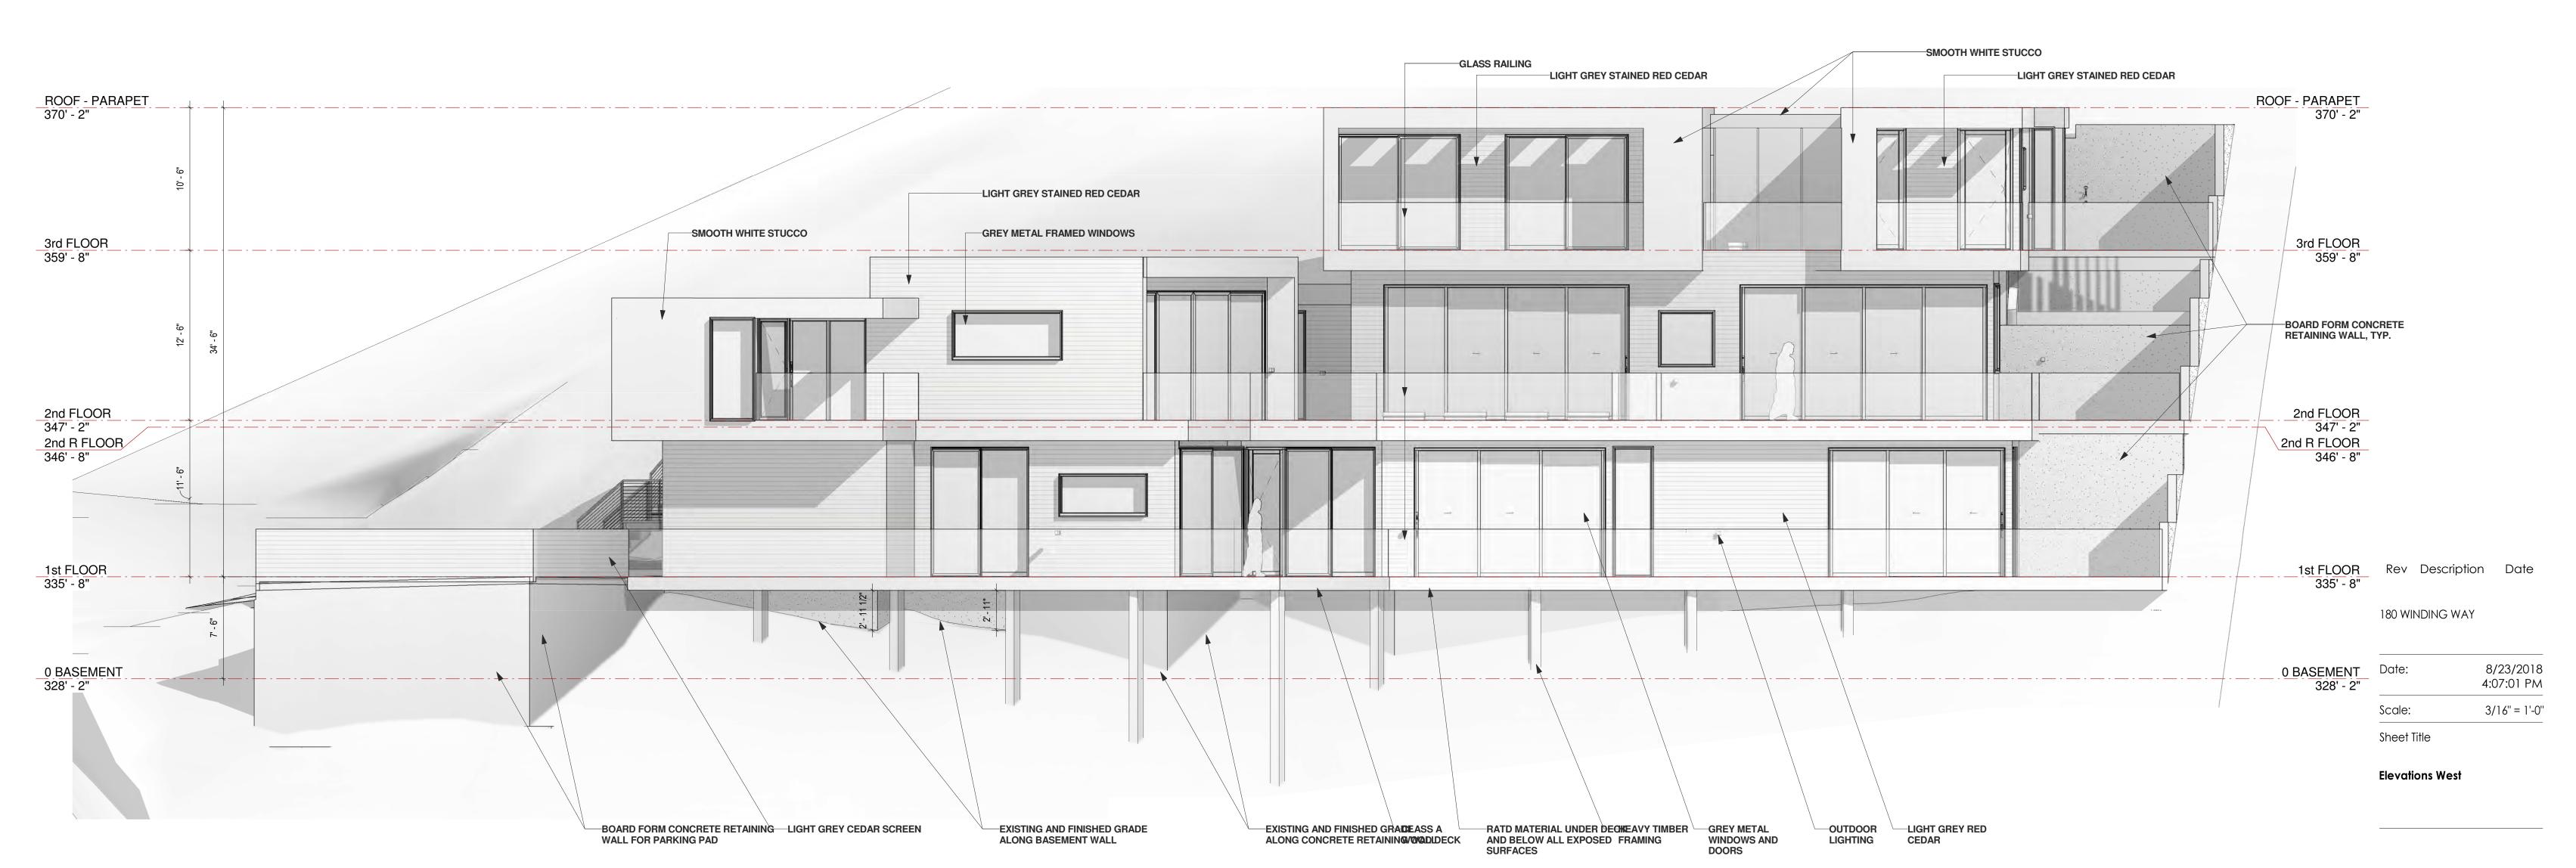


WEST REAR ELEVATION
3/16" = 1'-0"





180 WINDING WAY SAN CARLOS, CA 94070

BLOCK/LOT:Project Number

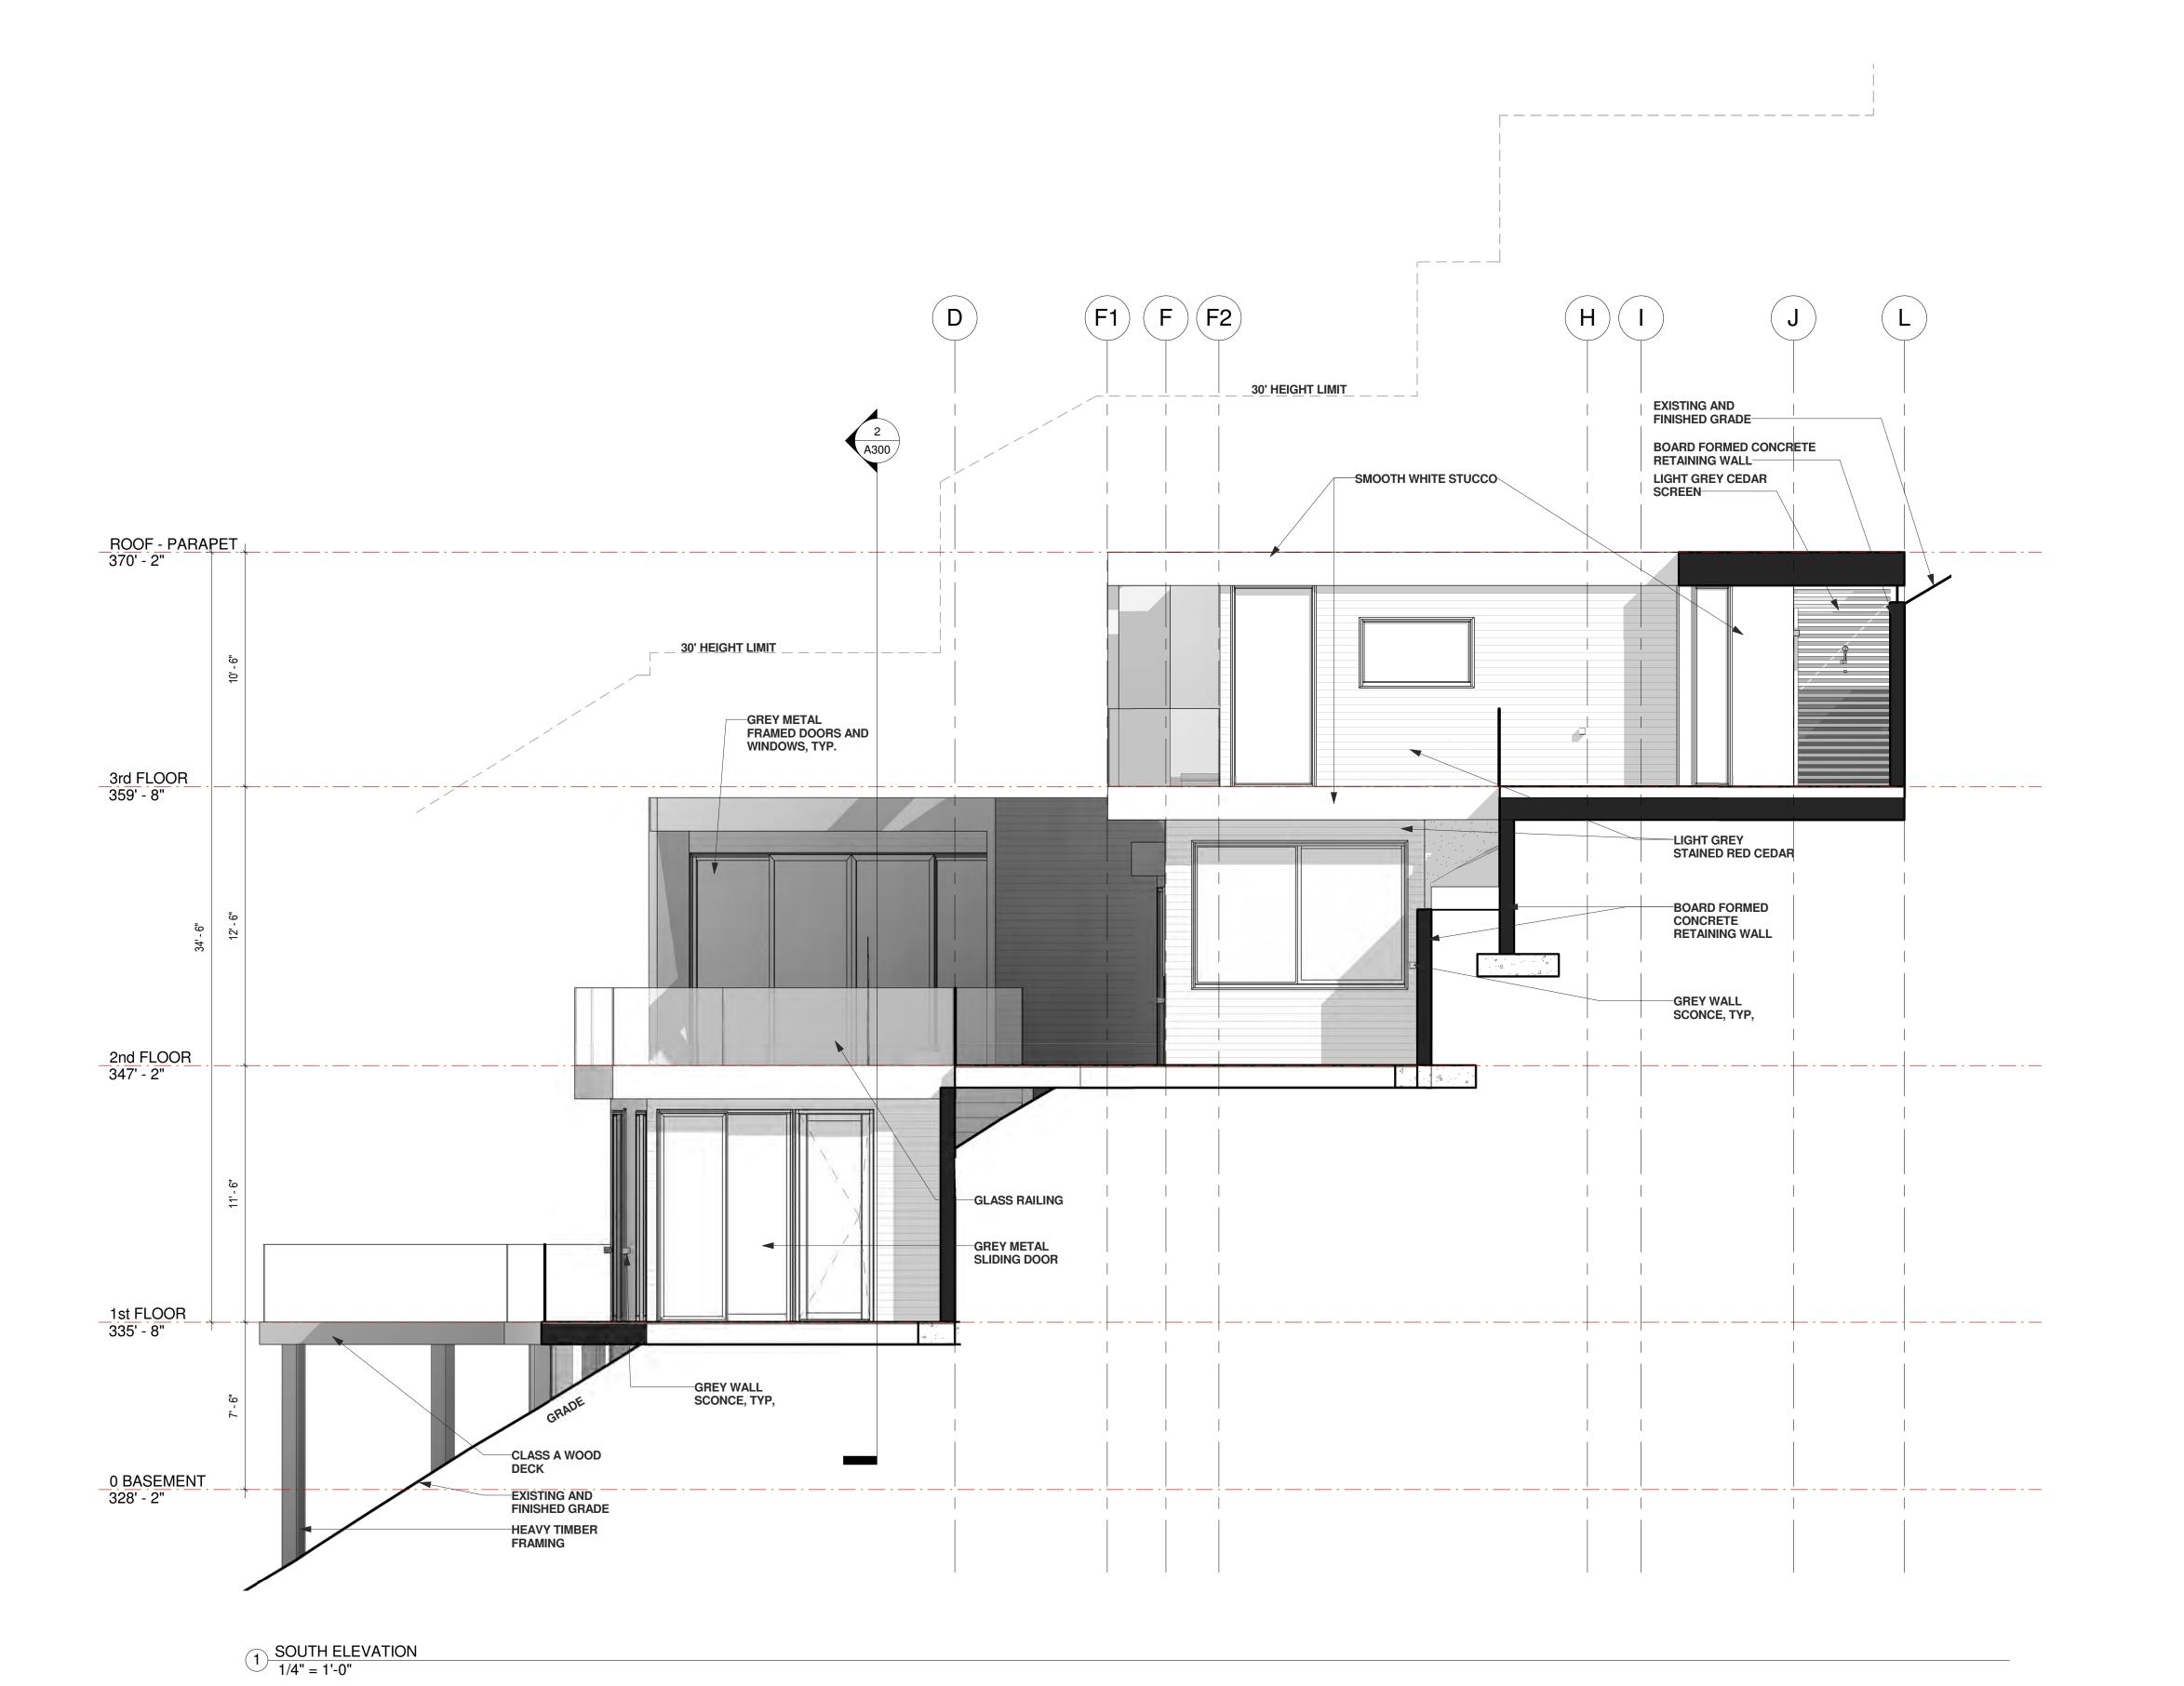

Rev Description Date

180 WINDING WAY

<u> — — — — — — — — — — — — — — — — — — —</u>	4:08:55 PM
Scale:	1/4" = 1'-0'

Sheet Title


Elevations South





180 WINDING WAY SAN CARLOS, CA 94070

BLOCK/LOT:Project Number

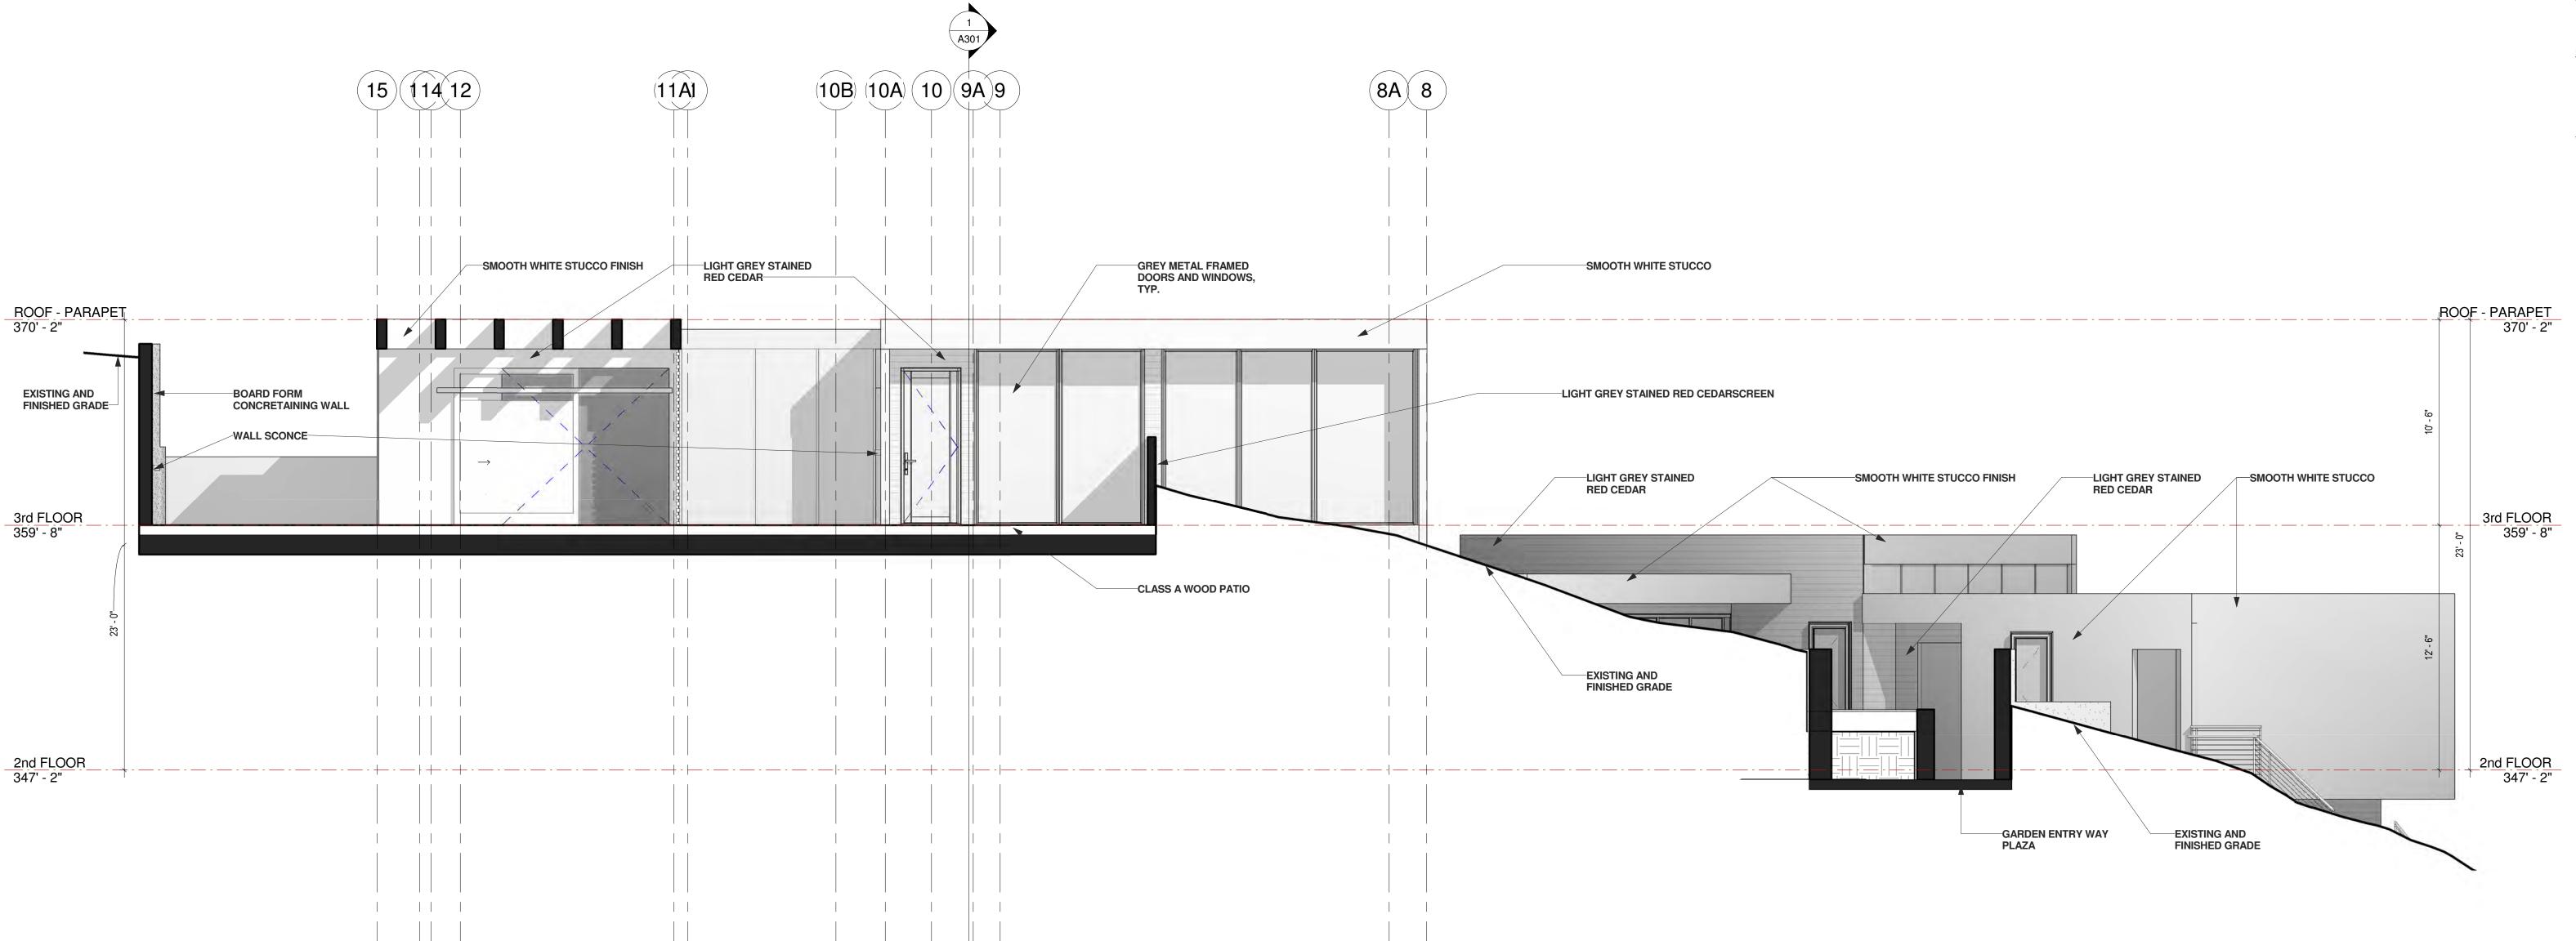


Rev Description Date

180 WINDING WAY

Date:	8/23/2018 4:10:15 PM
Scale:	1/4'' = 1'-0'
Sheet Title	

Elevations East

1 EAST ELEVATION 1/4" = 1'-0"

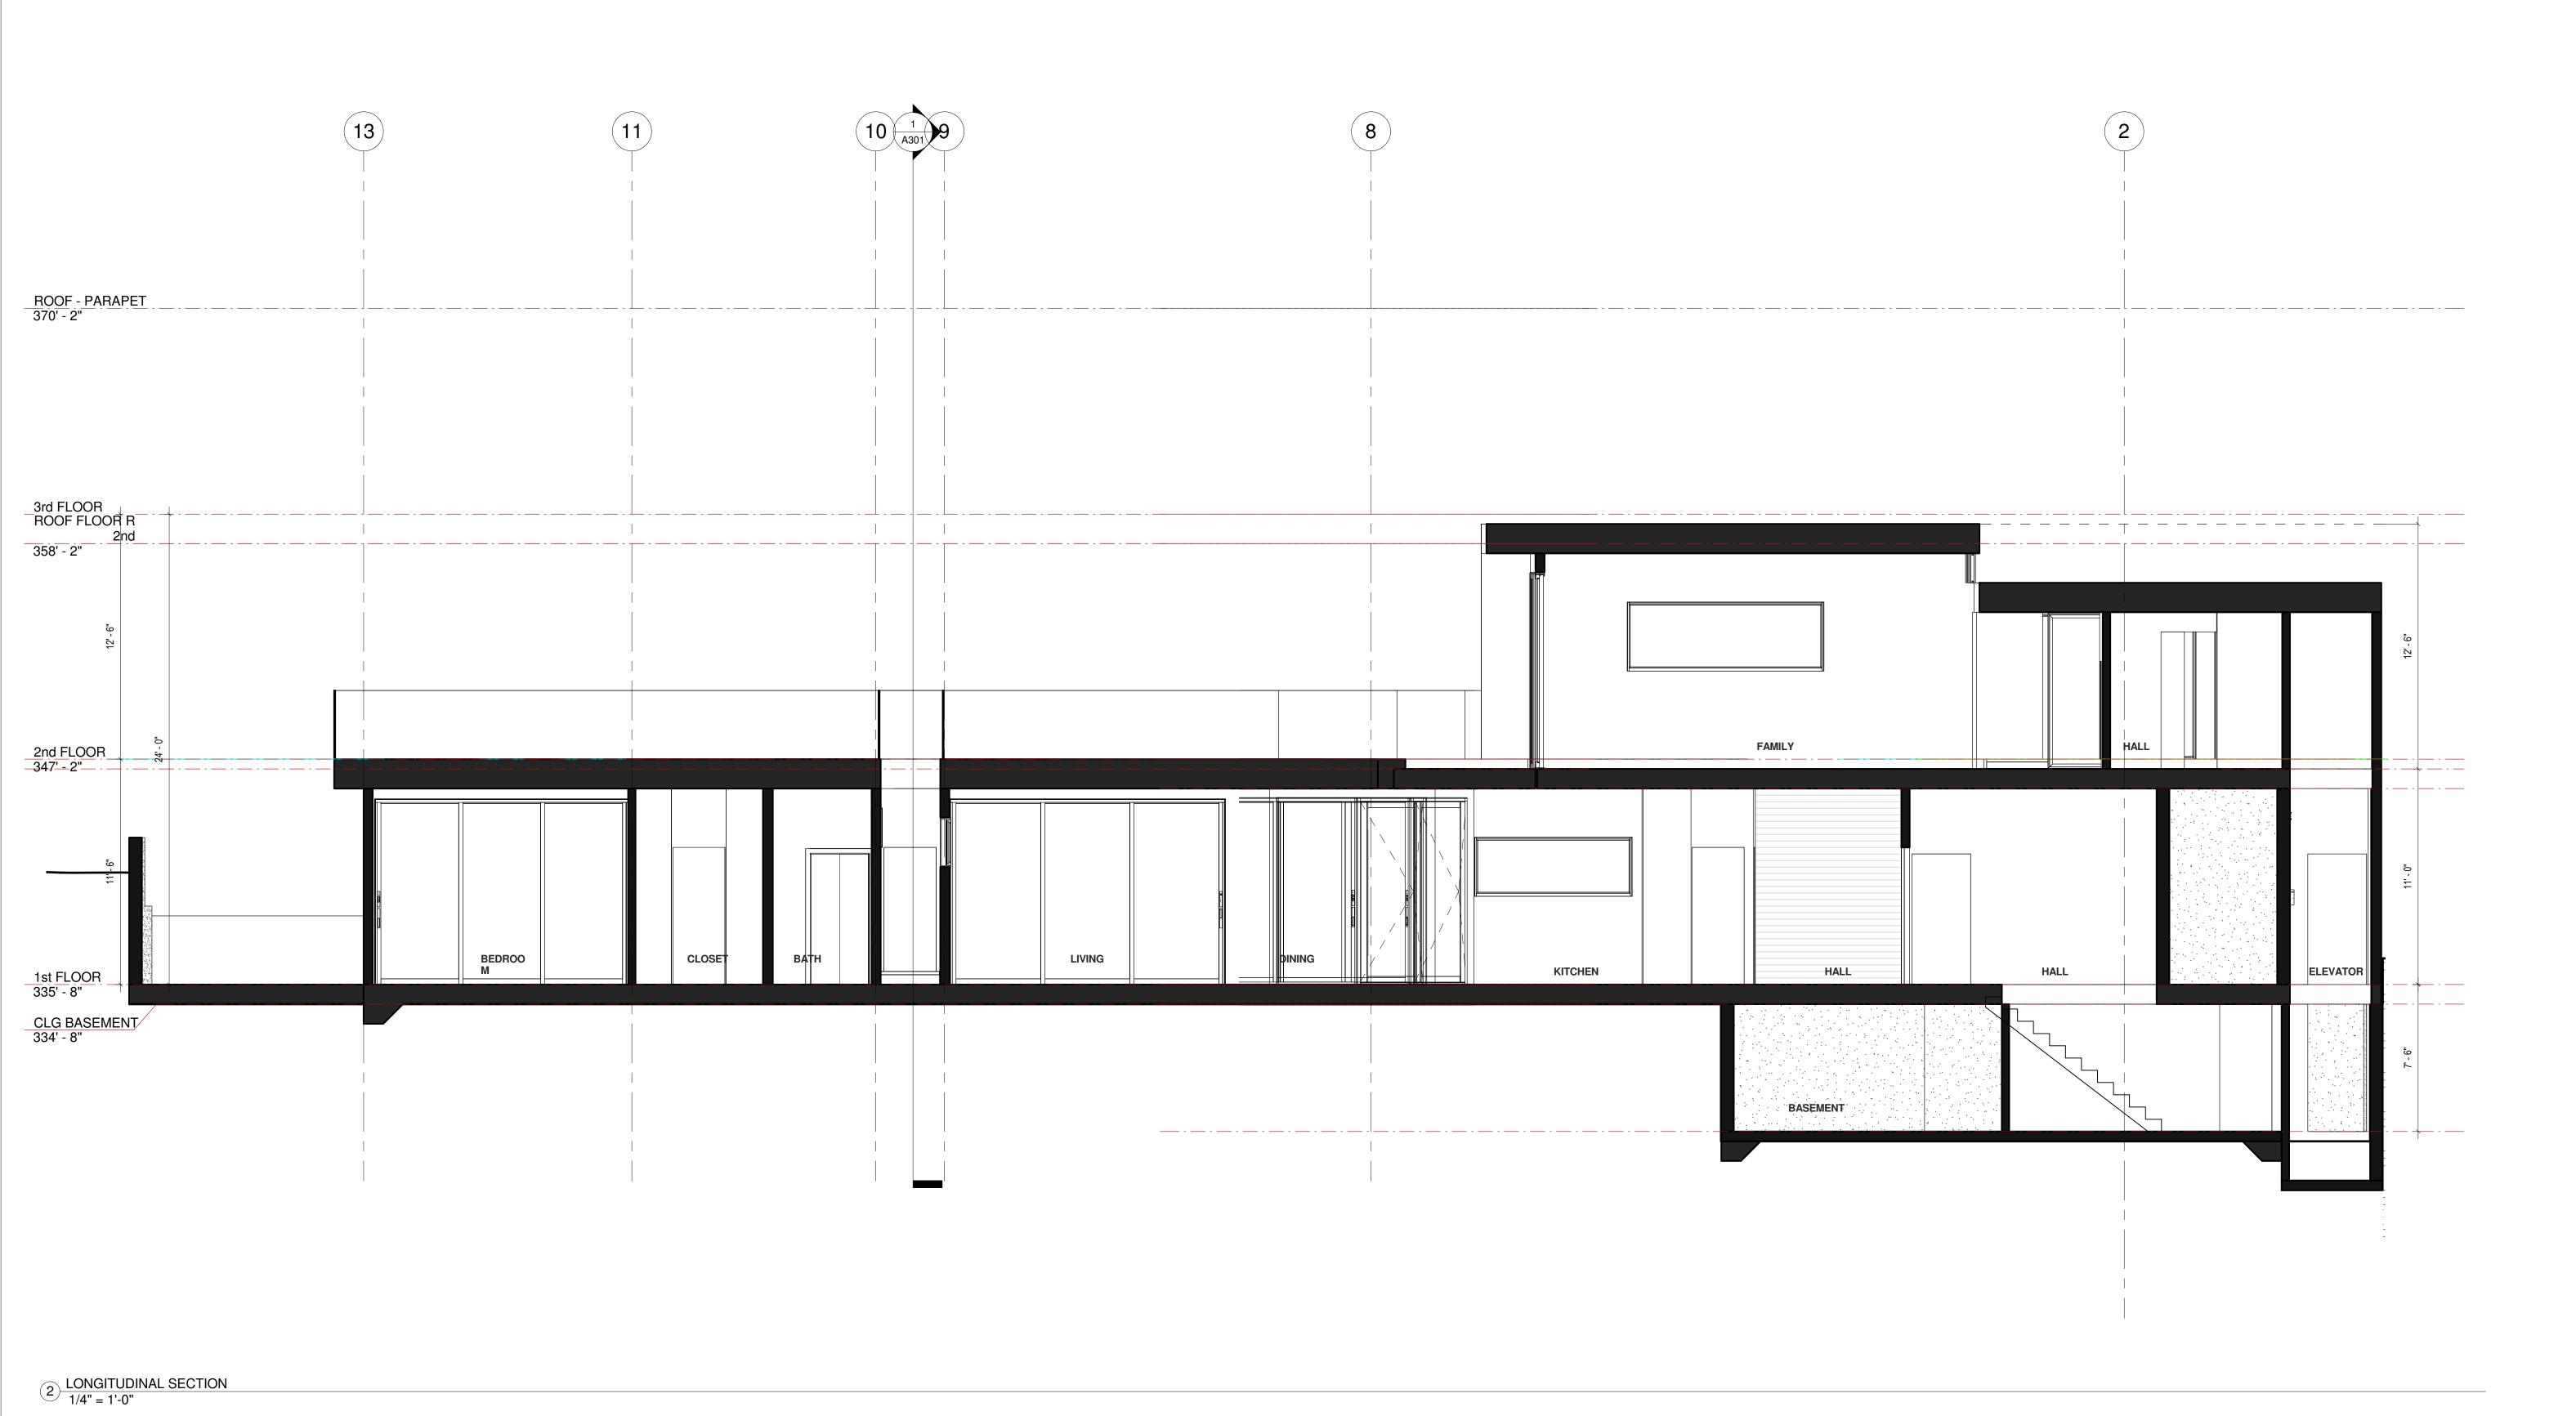





180 WINDING WAY SAN CARLOS, CA 94070

BLOCK/LOT:Project Number

Rev Description Date


180 WINDING WAY

Date: 8/23/2018 4:10:25 PM Scale: 1/4" = 1'-0"

Sheet Title


Longitudinal Section



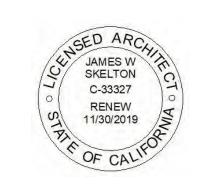

180 WINDING WAY SAN CARLOS, CA 94070

BLOCK/LOT:Project Number

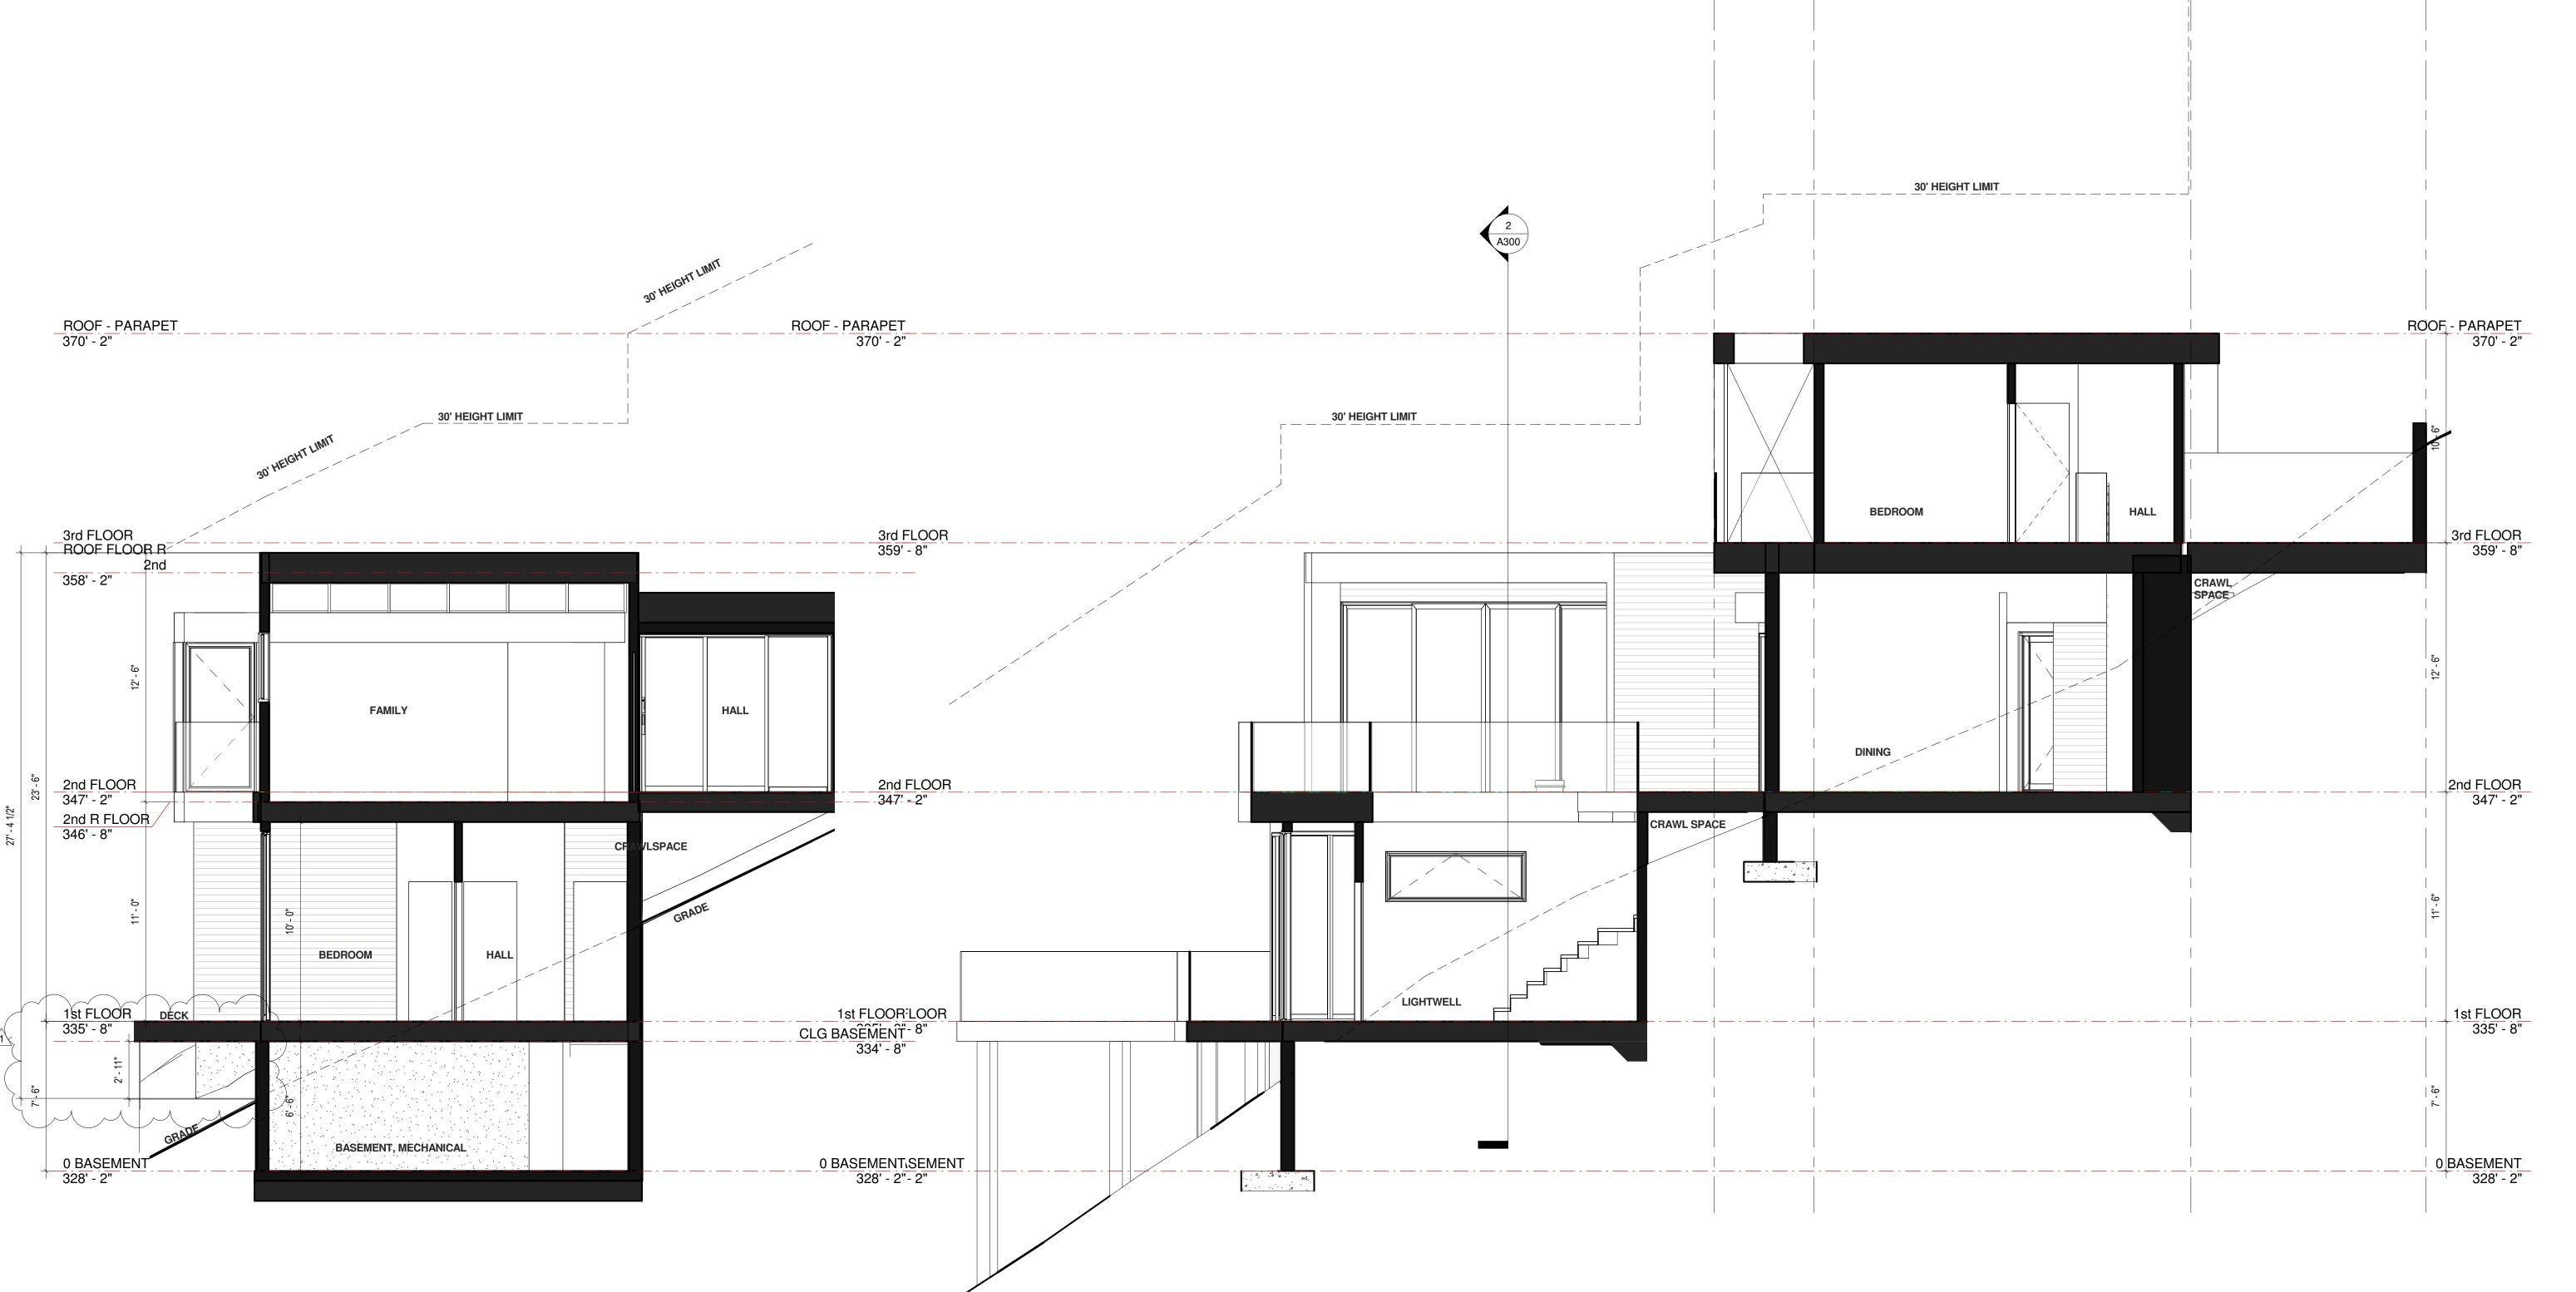

1 Revision 1 8/2/18
Comments
Rev Description Date

180 WINDING WAY

Date: 8/30/2018 5:10:37 PM Scale: 1/4" = 1'-0" Sheet Title

Lateral Sections

A 000

2 Lateral Section at Basement 1/4" = 1'-0"

Lateral Section at 1st 2nd and 3rd Floors

1/4" = 1'-0"